
EXHIBIT A:

Location Map and Permits, Plans & Specifications

(see attached site maps and plans)

SITE MAP OVERVIEW:

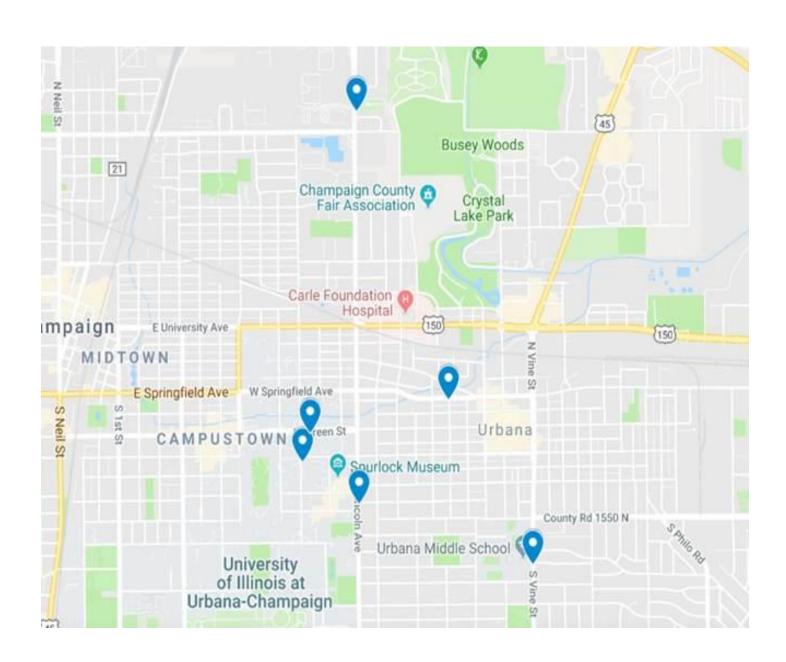


PACE: MRCHI025397 / MRCHI025475 SITE NAME: CRAN_RCHI_CHNOS_004

USID / NODE: 184197

ADDRESS: 1614 N. LINCOLN AVENUE, URBANA, IL 61801

COORDINATES: 40.128576, -88.219449

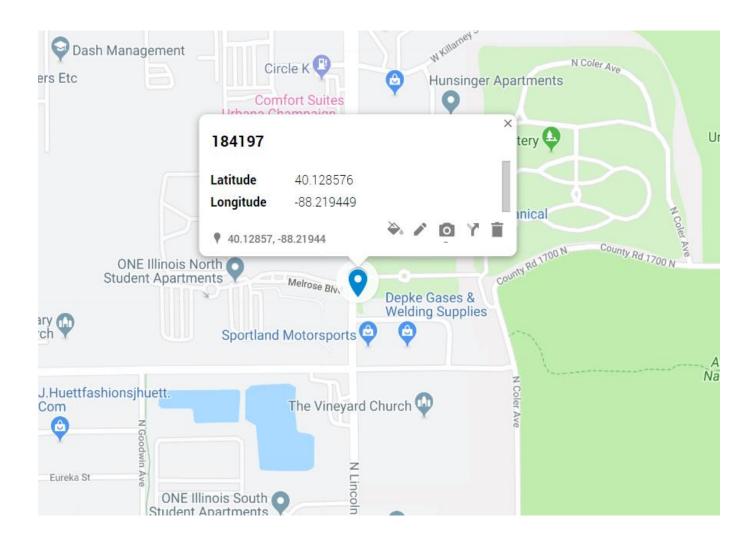


PACE: MRCHI025457 / MRCHI025418 SITE NAME: CRAN_RCHI_CHUOI_015

USID / NODE: 184220

ADDRESS: 402 W. SPRINGFIELD AVENUE, URBANA, IL 61801

COORDINATES: 40.112287, -88.212013

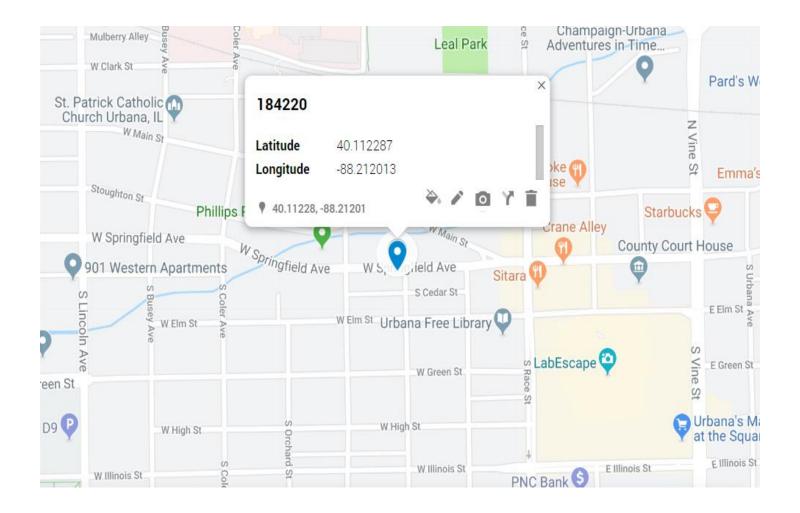


PACE: MRCHI025422 / MRCHI025403 SITE NAME: CRAN_RCHI_CHUOI_009

USID / NODE: 184214

ADDRESS: 544 S GOODWIN AVENUE, URBANA, IL 61801

COORDINATES: 40.108764, -88.223793

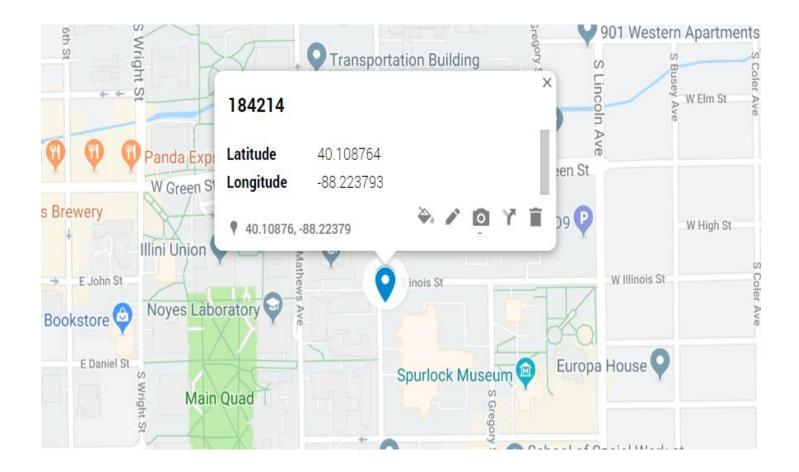


PACE: MRCHI025452 / MRCHI025399 SITE NAME: CRAN_RCHI_CHUOI_023

USID / NODE: 184228

ADDRESS: 1171 W GREEN STREET, URBANA, IL 61801

COORDINATES: 40.110346, -88.223195

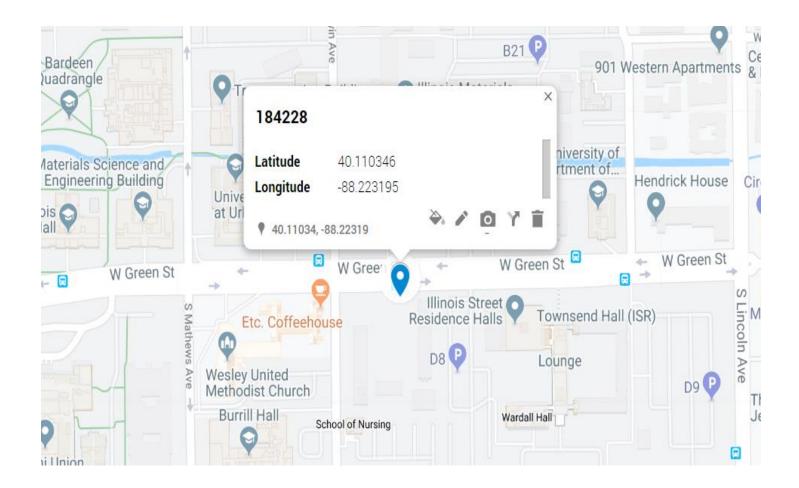


PACE: MRCHI025394 / MRCHI025420 SITE NAME: CRAN_RCHI_CHUOI_014

USID / NODE: 184219

ADDRESS: 1189 S VINE STREET, URBANA, IL 61801

COORDINATES: 40.102950, -88.205078

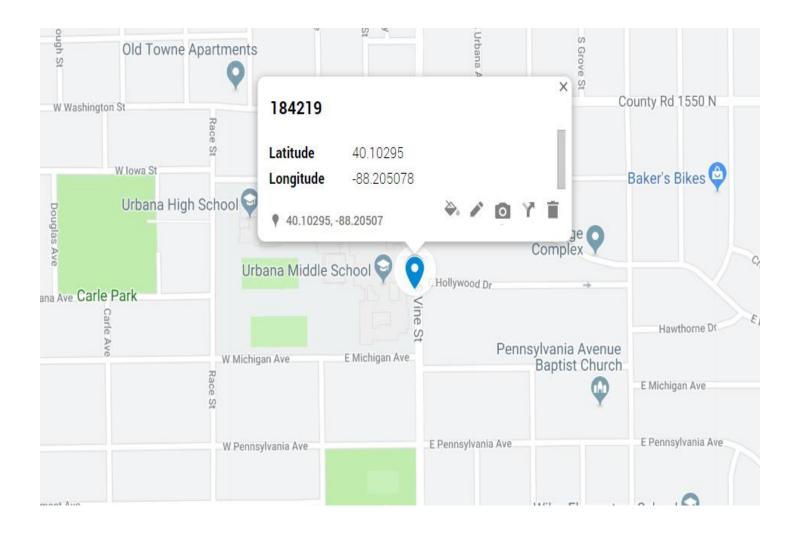


PACE: MRCHI025454 / MRCHI025479 SITE NAME: CRAN_RCHI_CHUOI_026

USID / NODE: 184230

ADDRESS: 784 S LINCOLN AVENUE, URBANA, IL 61801

COORDINATES: 40.106360, -88.2190583

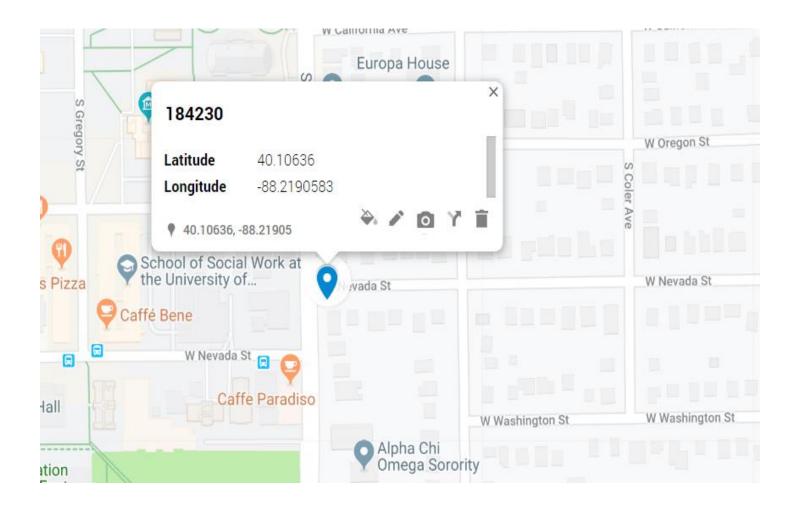

PROJECT INFORMATION

SITE NAME: COUNTY: ADDRESS:

CRAN_RCHI_CHNOS_004 CHAMPAIGN 1614 N. LINCOLN AVENUE

URBANA, IL 61801 CITY OF URBANA FA NUMBER: 14805856

LATITUDE: 40° 07' 42.37" (40.128576°)

LONGITUDE: **ELEVATION:**

LIGHT POLE/UTILITY POLE OWNÉR: CITY OF URBANA

APPLICANT:

AT&T MOBILITY 930 NATIONAL PARKWAY SCHAUMBURG IL 60173

3304A0AAQK / 3304A0AARE

MRCHI025397 / MRCHI025475

88° 13' 09.88" (-88.219449°)

AT&T_PROJECT

MANAGER/SITE ACQUISITION:

VANESSA ROSS (217) 814-2314 VF2021@ATT.COM

AT&T CONSTRUCTION

MANAGER:

CHRISTIANA RACHAL CR630A@ATT.COM

PROJECT CONSULTANTS

PROJECT MANAGER: SAC WIRELESS LLC

540 W. MADISON ST. (9TH FLOOR) CHICAGO IL 60661 CONTACT: PRITI MORE PHONE: (312) 789-4353 EMAIL: PRITI.MORE@SACW.COM

ARCHITECT:

GPD GROUP, INC. - 184-007100 520 S. MAIN ST., SUITE 2531 AKRON, OH 44311

JAMES HOM

SAC C.M. MARK KLEPACKI

EMAIL: MARK.KLEPACKI@SACW.COM

SAC P.M.

EMAIL: JAMES.HOM@SACW.COM

AT&T MOBILITY

PROJECT: LTE 1C&2C MICRO CELL BUILD

SITE #: CRAN_RCHI_CHNOS 004

USID / NODE: 184197 FA #: 14805856

PTN #: 3304A0AAQK / 3304A0AARE PACE #: MRCHI025397 / MRCHI025475

ENODEB NAME: ILL07001F R01 JURISDICTION: CITY OF URBANA

SITE NAME: CRAN_RCHI_CHNOS_004 1614 N. LINCOLN AVENUE **ADDRESS:**

URBANA, IL 61801

VICINITY MAP LOCATION MAP NOT TO SCALE NOT TO SCALE



DRAWING INDEX TITLE SHEET FIBER DELIVERY PLANS (REFERENCE ONLY) A2 OVERALL SITE PLAN Α3 ENLARGED PLAN **FXISTING LIGHT POLE FLEVATION** PROPOSED LIGHT POLE ELEVATIONS A5 A6 EQUIPMENT DETAILS (REFERENCE ONLY) Α7 MOUNTING DETAILS S1 POLE FOUNDATION DETAILS ELECTRICAL ONE-LINE DIAGRAM E2 PANEL SCHEDULE & ELECTRICAL DETAILS E3 GROUNDING DETAILS RF1 RF PLUMBING DIAGRAM (REFERENCE ONLY) POLE MANUFACTURER DESIGN (BY OTHERS)

SCOPE OF WORK

THIS IS NOT AN ALL INCLUSIVE LIST. CONTRACTOR SHALL UTILIZE SPECIFIED EQUIPMENT PART OR ENGINEER APPROVED EQUIVALENT. CONTRACTOR SHALL VERIFY ALL NEEDED EQUIPMENT TO PROVIDE A FUNCTIONAL SITE. THE PROJECT GENERALLY CONSISTS OF THE FOLLOWING:

- REMOVE EXISTING LIGHT POLE AND REPLACE WITH NEW 40'-0" VALMONT ALUMINUM (MODEL# 400086106D4Z) LIGHT POLE (100 GRIT SATIN FINISH)
- INSTALL NEW ELECTRIC SERVICE RUN FROM EXISTING SOURCE TO NEW LIGHT POLE. METER SUPPLIED & INSTALLED BY CONTRACTOR.
- INSTALL NEW FIBER SERVICE RUN FROM EXISTING SOURCE TO NEW LIGHT POLE LOCATION AS SHOWN.
- INSTALL NEW POWER & FIBER EQUIPMENT PER PLAN
- INSTALL (1) NEW OMNI ANTENNA
- INSTALL (1) PCS RRUS-4415 & (1) 700 RRUS-11
- INSTALL CABLING AS REQUIRED
- GROUND AS REQUIRED
- GROUND A RECONTED LIGHT POLE LUMINARY TO BE SUPPLIED & INSTALLED BY CONTRACTOR. LUMINARY MUST BE APPROVED BY CITY OF URBANA PRIOR TO ORDER.
- STREET LIGHTING HANDHOLE (IF REQUIRED) SUPPLIED & INSTALLED BY
- POTHOLING SHALL BE REQUIRED FOR ANY PROPOSED UTILITY CROSSING
- HYDROVAC SHALL BE USED FOR ALL TRENCHING & POTHOLING ACTIVITIES CONTRACTOR SHALL MAINTAIN INTEGRITY OF EXISTING POLE DURING REMOVAL & COORDINATE RETURN OF REMOVED POLE TO THE CITY OF URBANA

UTILITY DELIVERY METHOD TO PROPOSED POLE - FIBER - UNDERGROUND

- POWER - UNDERGROUND

CODE COMPLIANCE

- 2015 INTERNATIONAL BUILDING CODE W/CITY AMMENDMENTS
- 2014 NATIONAL ELECTRIC CODE W/CITY AMMENDMENTS

SPECIAL NOTES

- ALL WORK SHALL BE INSTALLED IN CONFORMANCE WITH CURRENT AT&T CONSTRUCTION INSTALLATION GUIDE.
- EXISTING CONDITIONS WILL BE CHANGED & VERIFIED IN FIELD. IF SIGNIFICANT DEVIATIONS OR DETERIORATION ARE ENCOUNTERED AT THE TIME OF CONSTRUCTION, A REPAIR PERMIT WILL BE OBTAINED & CONTRACTOR SHALL NOTIFY ENGINEER IMMEDIATELY.
- THESE DRAWINGS ARE FULL SIZE & SCALEABLE ON 11"X17" SHEET SIZE. STATEMENT THAT COMPLIANCE WITH THE ENERGY CODE IS NOT REQUIRED. -SCOPE OF WORK DOES NOT INVOLVE MODIFICATIONS TO EXTERIOR ENVELOPE OF BUILDING, HVAC SYSTEMS OR ELECTRICAL LIGHTING

DO NOT SCALE DRAWINGS

CONTRACTOR SHALL VERIFY ALL PLANS & EXISTING DIMENSIONS & CONDITIONS ON THE JOB SITE & SHALL IMMEDIATELY NOTIFY THE ARCHITECT OR ENGINEER IN WRITING OF ANY DISCREPANCIES BEFORE PROCEEDING WITH THE WORK OR BE RESPONSIBLE FOR SAME.





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REVISIONS						
REV.	v. DATE DESCRIPTION					
Α	10/25/18	ISSUED FOR REVIEW	DTC			
œ	03/12/19	REVISED PER COMM.	MRL			
С	05/02/19	ADDED FOUNDATION	MRL			
NOT FOR CONSTRUCTION UNLESS LABELED AS CONSTRUCTION SET						

HEREBY CERTIFY THAT THIS PLAN, HERBI CERTIFI THAI HIS FLAN, SPECIFICATION, OR REPORT WAS SPEPARED BY ME OR UNDER MY DIRECT SUPERVISION AND THAT I AM A DULY LICENSED PROFESSIONAL ENGINEER UNDER THE LAWS OF THE

CIVIL SEAL


LTE 1C&2C MICRO CELL BUILD 14805856 CRAN_RCHI_CHNOS_004 184197 1614 N. LINCOLN AVENUE URBANA, IL 61801

SHEET TITLE

TITLE SHEET

SHEET NUMBER

SAC File: T:\ATandT\184197\01 2017732 44 SAC\AE\CD\CRAN_RCHI_CHNOS_004 URBANA CD.dwg 05/02/19 10:05

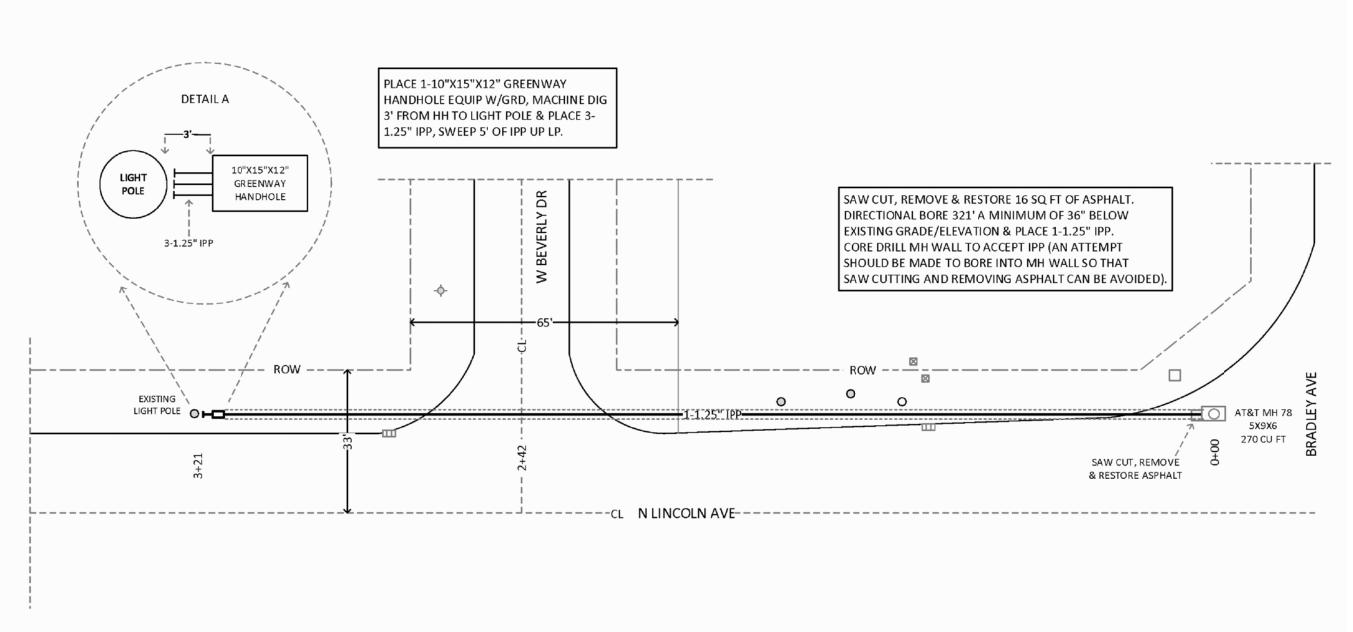





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REFERENCE ONLY

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SHEET TITLE

FIBER DELIVERY PLANS

SHEET NUMBER

A1

CITY OF URBANA

PERMIT SKETCH COUNTY: CHAMPAIGN


TOWNSHIP: CUNNINGHAM

SECTION: SW 1/4 5 REF # A01BRSR

SHEET 1 of 1

FIBER DELIVERY PLANS

SCALE N.T.S.

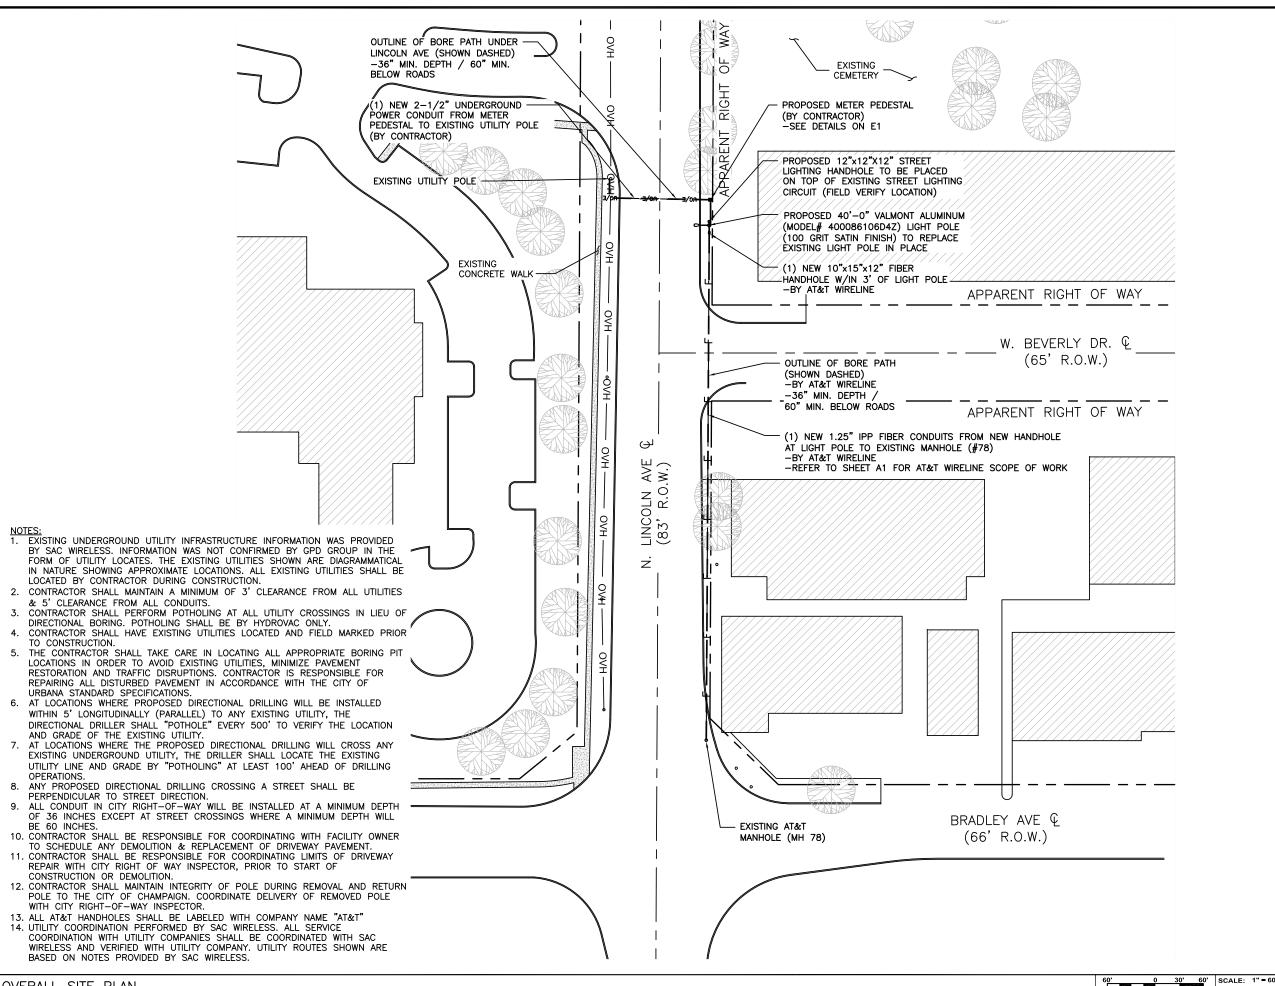







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ı	(REVISIONS)							
	REV.	, DATE DESCRIPTION INITIA						
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	В	03/12/19	REVISED PER COMM.	MRL				
	С	05/02/19	ADDED FOUNDATION	MRL				

NOT FOR CONSTRUCTION UNLESS LABELED AS CONSTRUCTION SET

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LTE 1C&2C MICRO CELL BUILD 14805856 CRAN_RCHI_CHNOS_004 184197 1614 N. LINCOLN AVENUE URBANA, IL 61801

SHEET TITLE


OVERALL SITE PLAN

SHEET NUMBER

A2

0 30' 60' SCALE: 1" = 60'-0" (24x36)

OVERALL SITE PLAN

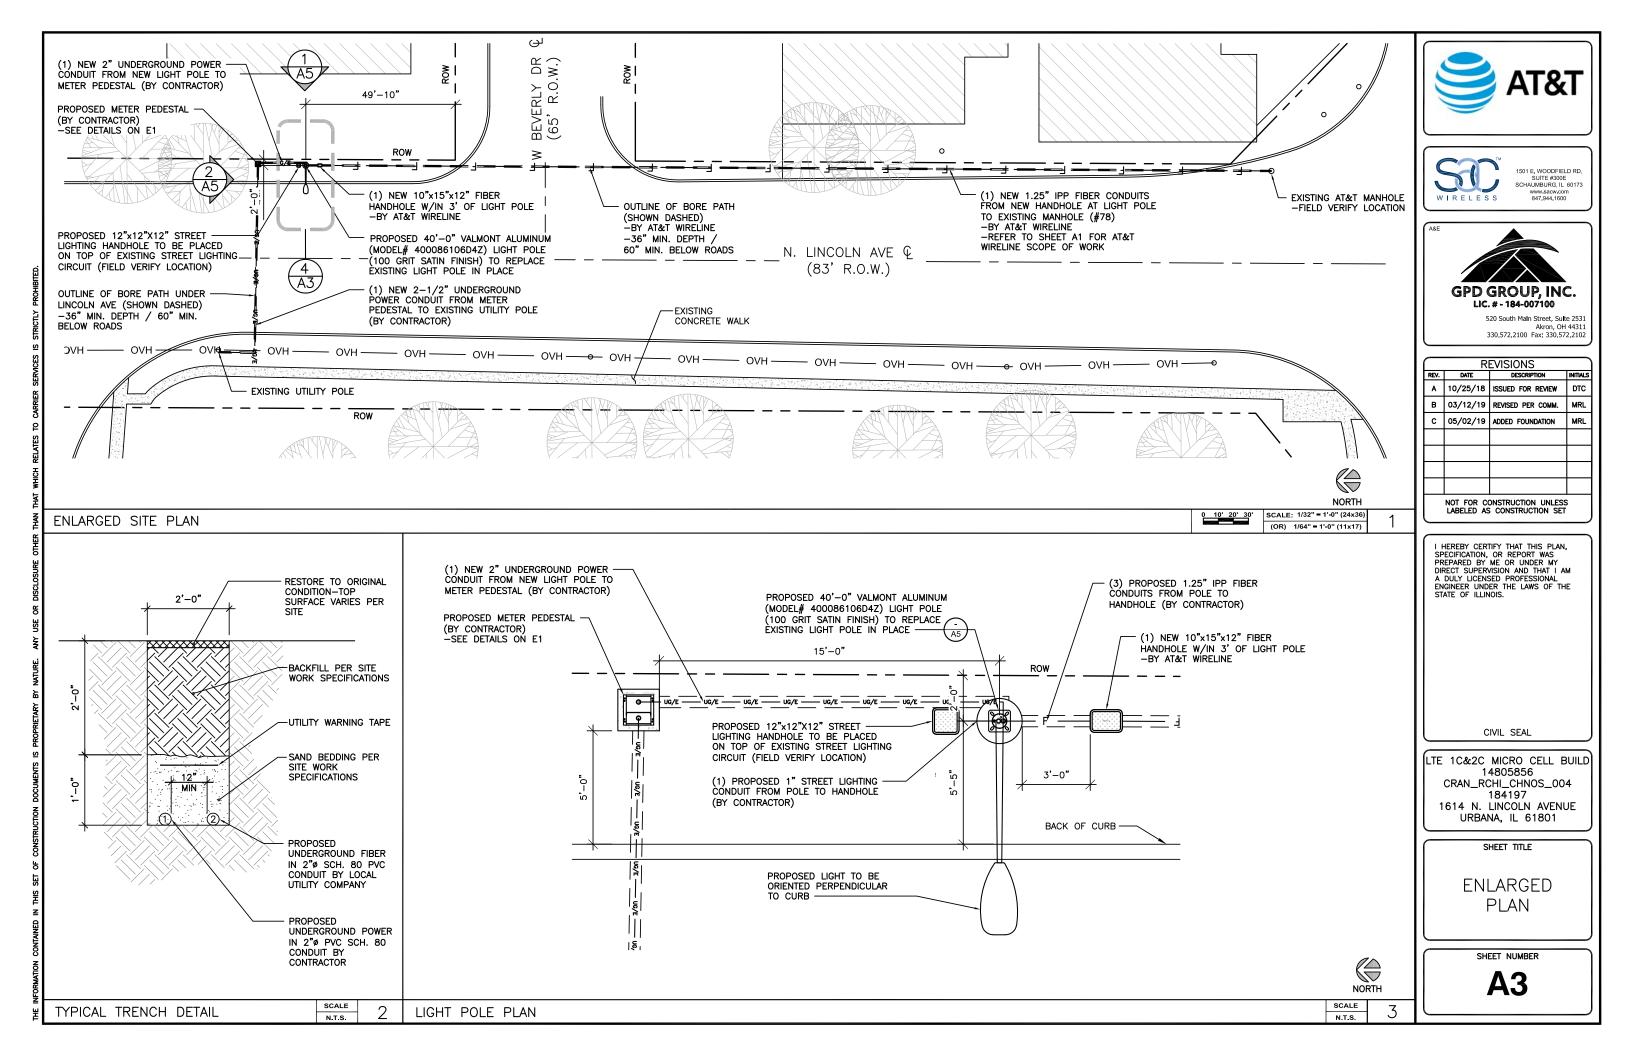







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Α	10/25/18	ISSUED FOR REVIEW	DTC					
В	03/12/19	REVISED PER COMM.	MRL					
С	05/02/19	ADDED FOUNDATION	MRL					

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CIVIL SEAL

LTE 1C&2C MICRO CELL BUILD 14805856 CRAN_RCHI_CHNOS_004 184197 1614 N. LINCOLN AVENUE URBANA, IL 61801

SHEET TITLE


EXISTING LIGHT POLE ELEVATION

SHEET NUMBER

A4

0 1.5' 3' 5'

5' SCALE: 3/16" = 1'-0" (24x36) (OR) 3/32" = 1'-0" (11x17)

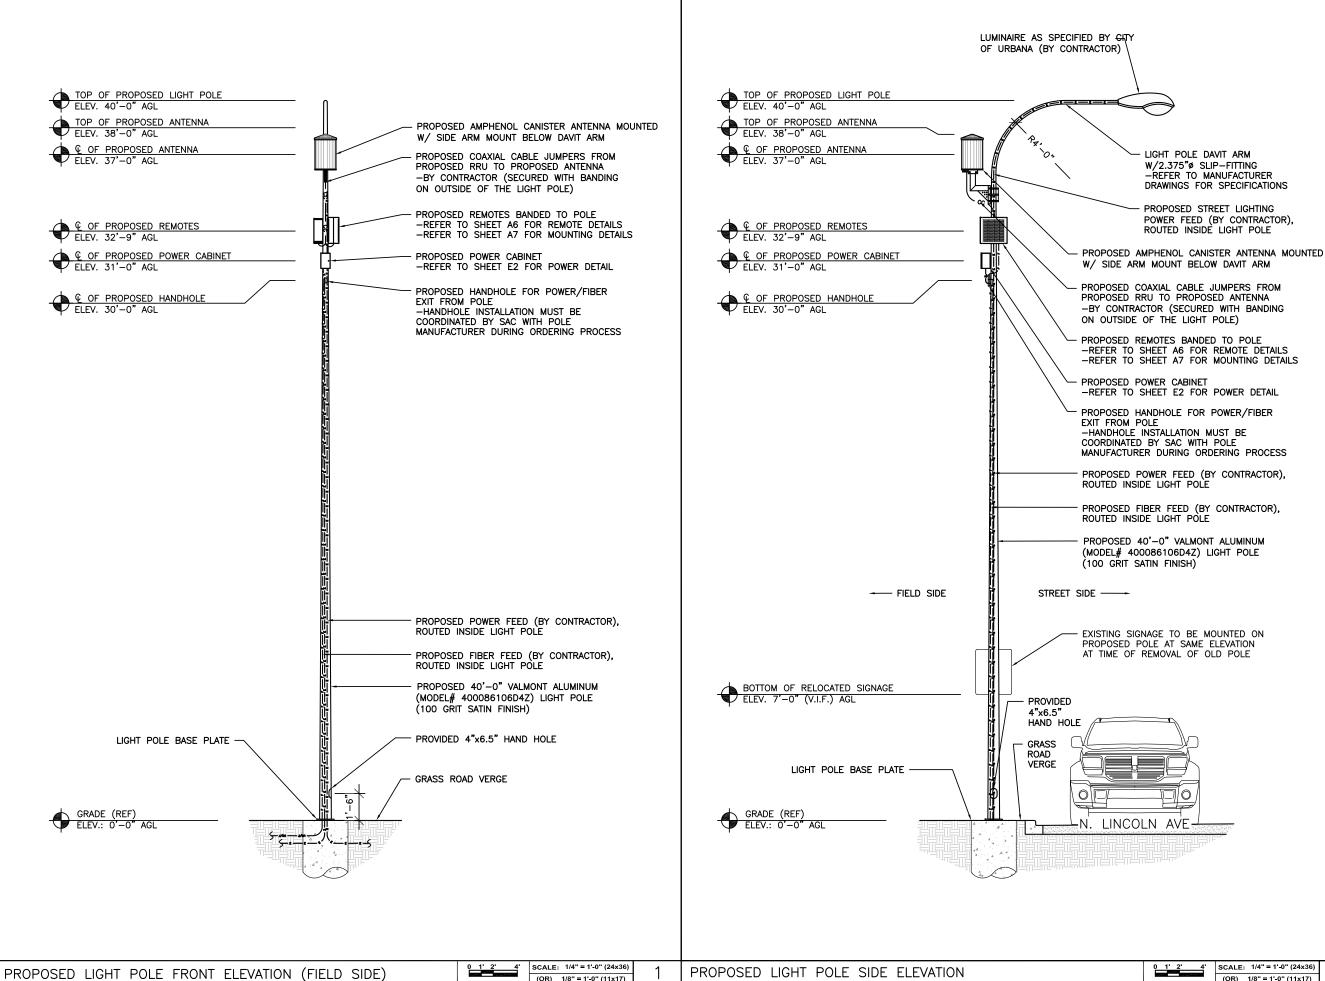







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В	03/12/19	REVISED PER COMM.	MRL				
С	05/02/19	ADDED FOUNDATION	MRL				
NOT FOR CONSTRUCTION UNITES							

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LABELED AS CONSTRUCTION UNLESS

CIVIL SEAL

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SHEET TITLE

PROPOSED LIGHT POLE **ELEVATIONS**

SHEET NUMBER

A5

SCALE: 1/4" = 1'-0" (24x36) (OR) 1/8" = 1'-0" (11x17)

PROPOSED LIGHT POLE SIDE ELEVATION

SCALE: 1/4" = 1'-0" (24x36) (OR) 1/8" = 1'-0" (11x17)

2

MANUFACTURER: MODEL: MECHANICAL SPECIFICATIONS: HEIGHT:

WEIGHT:

14.96 IN (380mm) 13.19 IN (335mm) 5.39 IN (137mm) 46 LBS (21kg)

INTERFACE SPECIFICATIONS:

2x2.5/4.9/9.8/10.1 Gbps (ONLY USE ERICSSON SUPPLIED AND APPROVED SFPs) 2

ERICSSON RRUS 4415 B25

EXTERNAL ALARMS:

14.96" (380mm)



MANUFACTURER: MODEL: ERICSSON RRUS-11

MECHANICAL SPECIFICATIONS: HEIGHT: WIDTH: DEPTH: WEIGHT:

19.7 IN (500mm) 17.0 IN (431mm) 7.2 IN (182mm) 50.7 LBS (23kg)


2x7/16 IEC-169-4

-48 VDC OR 100-250 VAC

INTERFACE SPECIFICATIONS: ANTENNA PORTS: OPTICAL INDICATORS: EXTERNAL ALARMS: FIELD GROUND:

ELECTRICAL SPECIFICATIONS: POWER SUPPLY:

ENVIRONMENTAL SPECIFICATIONS: NORMAL OPERATING TEMP.: RELATIVE HUMIDITY: -40°C TO +55°C 5-100%

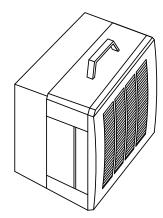




RRUS 4415 B25 DETAILS

DETAIL NOT USED

SCALE N.T.S.


RRUS-11 DETAILS

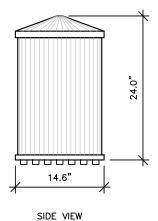



AMPHENOL MULTI BAND CANISTER ANTENNA MODEL: 2C2U3MT360X06Fxys0 COLOR: GREY

IMAGE

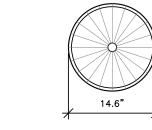

MECHANICAL CHARACTERISTICS

- ANTENNA DIMENSIONS (HEIGHT X DIAMETER) :
- WEIGHT W/OUT MOUNTING BRACKET KIT:
- SURVIVAL WIND SPEED:

- WIND AREA: - WIND LOAD (100 MPH):

TOP VIEW

24.0"x14.6" TBD LBS 150 MPH 2.4 FT² 43 LBF

A6

ANTENNA DETAIL

SCALE: NTS

4

SCALE N.T.S.

SCALE

N.T.S.

EQUIPMENT DETAILS SHEET NUMBER

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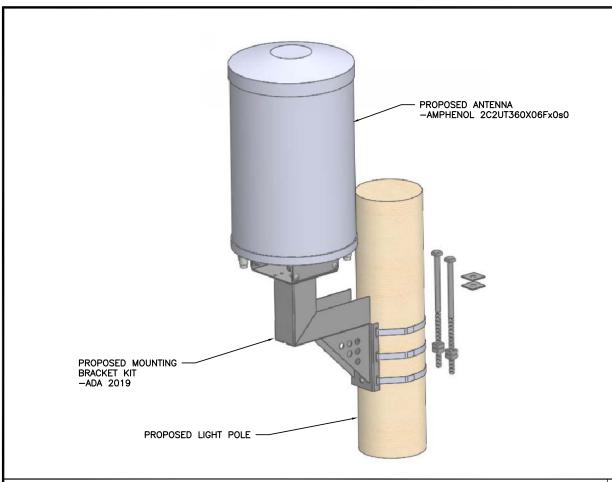
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REFERENCE ONLY

LTE 1C&2C MICRO CELL BUILD 14805856 CRAN_RCHI_CHNOS_004


184197 1614 N. LINCOLN AVENUE URBANA, IL 61801

SHEET TITLE



ANTENNA MOUNTING DETAIL

SCALE

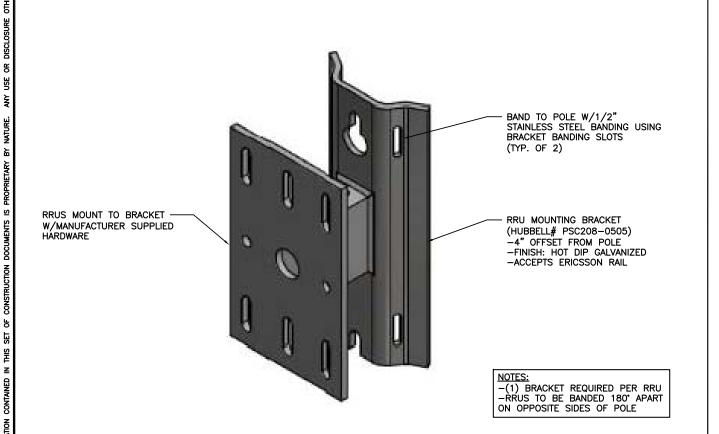


EXAMPLE CRAN RF CAUTION SIGN

A CAUTION A AT&T operates antennas at this structure Above this point you are entering an area where radio frequency (RF) fields may exceed the FCC General Occupational Exposure limits. Follow safety guidelines for working in an RF environment Keep 1 ft. away from the fronts of

Contact AT&T at 800-638-2822, opt. 9, 3 and follow their instructions prior to performing any maintenance or repairs above this point.

Cell Site USID.

EXAMPLE CRAN RF NOTICE SIGN

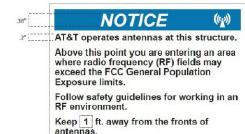

Contact AT&T at 800-638-2822, opt. 9, 3 and follow their instructions prior to

performing any maintenance or repairs above this point.

This is AT&T Site USID_

EXAMPLE CRAN POLE POWER DISCONNECT SIGN

DISCONNECT AC & DC POWER BOTH BEFORE WORKING ON POLE

Contact AT&T at 800-638-2822, opt. 9, 3 and follow their instructions prior to performing any maintenance or repairs above this point. Cell Site USID

EXAMPLE STONEHOUSE RD899 RF NOTICE SIGN

NOTICE

RF energy emitted by this antenna may exceed the FCC's exposure limits for the general population.

Stay at least 1 feet away from the antenna.

Call AT&T at 800-638-2822, option 9 then 3, for help if you need access within 3 feet.

STONEHOUSE RD899

16.5 pt.

CRAN Pole Power Disconnect, RF Notice, and Caution signs shall be ordered through Stonehouse Signs. Three versions are available for each of the signs shown in Figures 16, 17, and 18: .055 Polyethylene – Reflective, .025 Aluminum – Reflective, and Peel Back Label – Reflective. All versions are 6°x6" with font designed to be visible from 2-3 feet away when approached from below to provide warning about ascending into the high RF exposure areas. The RF Caution sign shown in Figure 19 is designed to be visible from 3 feet away and is available in the reflective peel back label version only. It is designed to fit on most of the CRAN/Small Cell antenna types currently deployed. It may also be placed on antenna shrouds as shown in Figures 11 and 12.

SIGNAGE NOTE:
SIGNAGE SHALL BE INSTALLED PER AT&T DIRECTION





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В	03/12/19	REVISED PER COMM.	MRL			
С	05/02/19	ADDED FOUNDATION	MRL			
	•					

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CIVIL SEAL

LTE 1C&2C MICRO CELL BUILD 14805856 CRAN_RCHI_CHNOS_004 184197 1614 N. LINCOLN AVENUE URBANA, IL 61801


SHEET TITLE

MOUNTING DETAILS

SHEET NUMBER

A7

SCALE 3 RRU MOUNTING DETAIL AT&T SIGNAGE DETAIL SCALE: NTS N.T.S.

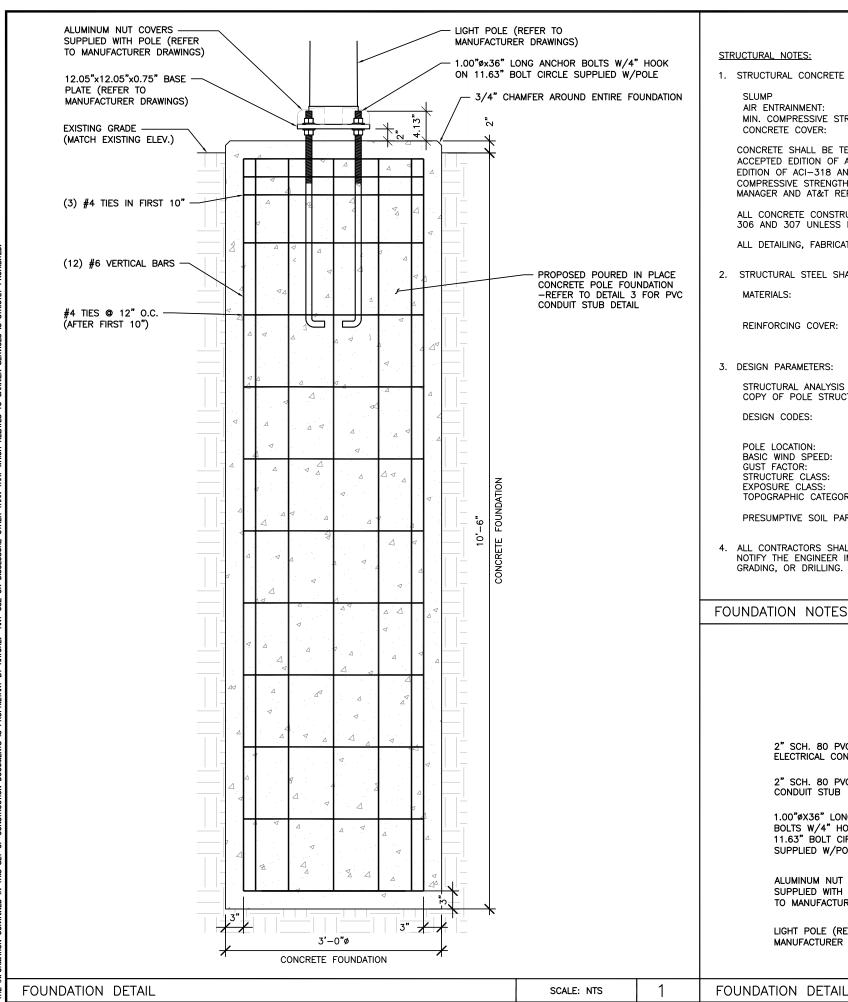

STRUCTURAL NOTES:

1. STRUCTURAL CONCRETE SHALL MEET THE FOLLOWING SPECIFICATIONS:

 $4" (\pm 1")$ AIR ENTRAINMENT: 6% (±1%) MIN. COMPRESSIVE STRENGTH (F'c): 4,500 PSI @ 28 DAYS CONCRETE COVER: 3" ALL SIDES

CONCRETE SHALL BE TESTED BY A REPUTABLE INDEPENDENT THIRD PARTY TESTING AGENCY IN ACCORDANCE WITH LATEST WISCONSIN ACCEPTED EDITION OF ACI-318. FIVE (5) CONCRETE CYLINDERS SHALL BE CAST IN ACCORDANCE WITH LATEST WISCONSIN ACCEPTED EDITION OF ACI-318 AND BE LABORATORY CURED. THE AVERAGE OF THREE (3) CONCRETE CYLINDERS SHALL HAVE A MINIMUM COMPRESSIVE STRENGTH (F'c) OF 4,500 PSI AT 28 DAYS. THE TESTING RESULTS SHALL BE PROVIDED TO THE CONSTRUCTION MANAGER AND AT&T REPRESENTATIVE.

ALL CONCRETE CONSTRUCTION SHALL CONFORM TO ACI*96, "STANDARD SPECIFICATION FOR STRUCTURAL CONCRETE" AND ACI 305, 306 AND 307 UNLESS NOTED OTHERWISE.

ALL DETAILING, FABRICATION AND PLACING OF CONCRETE SHALL CONFORM TO ACI 318-11.

2. STRUCTURAL STEEL SHALL MEET THE FOLLOWING SPECIFICATIONS:

REINFORCING ASTM 615, GRADE 60 MATERIALS: ANCHOR BOLTS ASTM F1554, GRADE 55

REINFORCING COVER: TOP воттом 3"

3. DESIGN PARAMETERS:

STRUCTURAL ANALYSIS OF THE POLE AND FOUNDATION WAS COMPLETED BY OTHERS. COORDINATE WITH SAC WIRELESS FOR A COPY OF POLE STRUCTURAL ANALYSIS.

DESIGN CODES: 2015 INTERNATIONAL BUILDING BUILDING CODE

TIA-222-G

POLE LOCATION: CHAMPAIGN COUNTY, IL

BASIC WIND SPEED: GUST FACTOR: 130 MPH 1.14 STRUCTURE CLASS: CLASS II

EXPOSURE CLASS: TOPOGRAPHIC CATEGORY:

MANUFACTURER DRAWINGS)

PRESUMPTIVE SOIL PARAMETERS: FOUNDATION IS BASED ON AN ALLOWABLE LATERAL BEARING PRESSURE OF AT LEAST 200 PSF/FT.

4. ALL CONTRACTORS SHALL EXERCISE GREAT CARE DURING EXCAVATION. CONTRACTOR SHALL PREDETERMINE UTILITY LOCATIONS AND NOTIFY THE ENGINEER IMMEDIATELY IF DEVIATION FROM PLANS EXIST. CONTRACTOR SHALL CONTACT 811 48 HR. PRIOR TO DIGGING, GRADING, OR DRILLING.

FOUNDATION NOTES

3'-0"ø REINFORCED CONCRETE FOUNDATION 2" SCH. 80 PVC LIGHTING 2" SCH. 80 PVC FIBER ELECTRICAL CONDUIT STUB CONDUIT STUB 2" SCH. 80 PVC ELECTRIC CONDUIT STUB 1.00"øX36" LONG ANCHOR BOLTS W/4" HOOK ON 1/2" SCH. 80 PVC 11.63" BOLT CIRCLE GROUNDING CONDUIT STUB SUPPLIED W/POLE ALUMINUM NUT COVERS -SUPPLIED WITH POLE (REFER 12.05"X12.05"X0.75" BASE PLATE TO MANUFACTURER DRAWINGS) (REFER TO MANUFACTURER DRAWINGS) LIGHT POLE (REFER TO





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С	05/02/19	ADDED FOUNDATION	MRL				
	NOT FOR O	ONCEDUCTION UNITED					

NOT FOR CONSTRUCTION UNLESS LABELED AS CONSTRUCTION SET

I HEREBY CERTIFY THAT THIS PLAN, I HEREBY CERTIFY THAI THIS PLAN, SPECIFICATION, OR REPORT WAS PREPARED BY ME OR UNDER MY DIRECT SUPERVISION AND THAT I AM A DULY LICENSED PROFESSIONAL ENGINEER UNDER THE LAWS OF THE STATE OF ILLINOIS.

SCALE

N.T.S.

2

3

SCALE: NTS

STRUCTURAL SEAL


LTE 1C&2C MICRO CELL BUILD 14805856 CRAN_RCHI_CHNOS_004 184197 1614 N. LINCOLN AVENUE URBANA, IL 61801


SHEET TITLE

POLE **FOUNDATION** DETAILS

SHEET NUMBER

S1

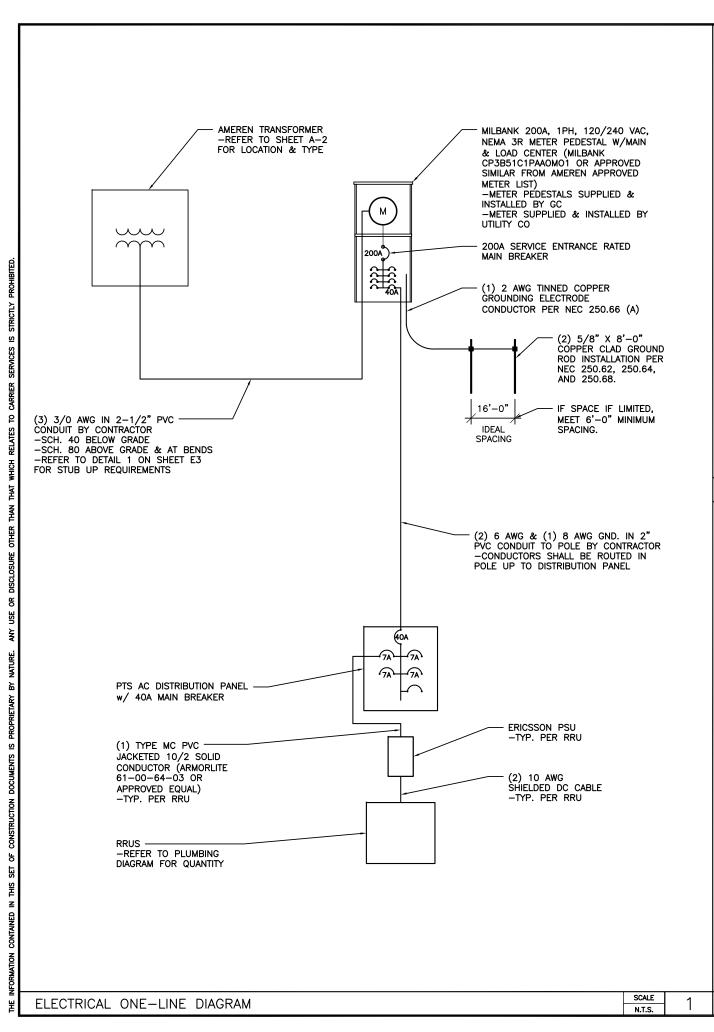

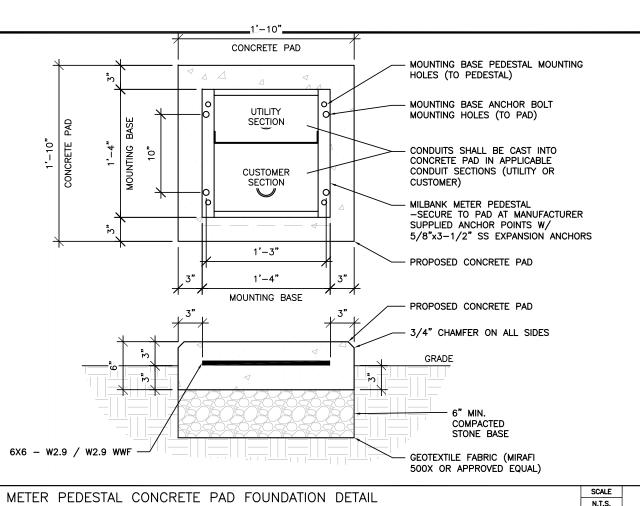

ELECTRICAL NOTES:

- 1. ALL ELECTRICAL WORK SHALL BE IN ACCORDANCE WITH THE PROJECT SPECIFICATIONS AND ALL APPLICABLE CODES.
- 2. CONDUIT ROUTINGS ARE SCHEMATIC. SUBCONTRACTOR SHALL INSTALL CONDUITS SUCH THAT ACCESS TO EQUIPMENT IS NOT BLOCKED.
- 3. SUBCONTRACTOR IS RESPONSIBLE FOR PROPERLY SEQUENCING THE INSTALLATION OF GROUNDING AND UNDERGROUND CONDUIT AS TO PREVENT THE LOSS OF CONTINUITY IN THE GROUNDING SYSTEM OR DAMAGE TO THE CONDUIT.
- 4. COMPRESSION GROUND CONNECTIONS MAY BE REPLACED BY EXOTHERMIC (CADWELD) CONNECTIONS WHEN APPROVED BY CINCINNATI BELL CONSTRUCTION MANAGER.
- 5. SERVICE TO METER PEDESTAL SHALL BE 120/240VAC, 200 AMP, SINGLE PHASE.
- 6. ALL GROUND CONNECTIONS BELOW GRADE SHALL BE EXOTHERMIC (CADWELD).
- 7. ALL GROUND CONNECTIONS ABOVE GRADE SHALL BE FORMED USING TWO (2) HIGH PRESS CRIMPS.
- ALL EXOTHERMIC CONNECTIONS TO THE GROUND RODS SHALL START AT THE TOP AND HAVE A VERTICAL SEPARATION OF 6" FOR EVERY ADDITIONAL CONNECTION.
- 9. ALL EXTERIOR GROUND CONNECTIONS SHALL BE COATED WITH A CORROSION RESISTANT MATERIAL.
- 10. ALL EXTERIOR GROUND CONNECTORS SHALL BE 2 AWG SOLID BARE, TINNED, COPPER UNLESS INDICATED OTHERWISE.
- 11. CONNECTIONS TO THE GROUND BUS SHALL NOT BE DOUBLED UP OR STACKED. BACK TO BACK CONNECTIONS ON OPPOSITE SIDES OF THE GROUND BUS ARE PERMITTED.
- 12. USE OF 90' BENDS IN THE PROTECTION GROUNDING CONDUCTORS SHALL BE AVOIDED WHEN 45' BENDS CAN BE ADEQUATELY
- 13. MAXIMUM RESISTANCE OF THE COMPLETED GROUND SYSTEM SHALL NOT EXCEED 5 OHMS. TESTING SHALL BE PERFORMED IN ACCORDANCE WITH PROJECT SPECIFICATIONS FOR FACILITY GROUNDING, USING FALL OF POTENTIAL METHOD.

STANDARD CONDUIT NOTES:

- 1. UNDERGROUND CONDUIT SHALL BE SCHEDULE 40 PVC. ABOVE GROUND CONDUIT, ELBOWS, AND RISERS SHALL BE SCHEDULE 80 PVC.
- 2. UNDERGROUND SERVICE CONDUIT SHALL MEET REQUIRED BURIAL DEPTH PER AMEREN ELECTRIC SERVICE MANUAL.
- 3. G.C. TO STUB UP SERVICE CONDUIT AT UTILITY POLE WITH 90' SWEEPING ELBOW. GC. SHALL COIL SUFFICIENT CONDUCTOR TO REACH SERVICE CONNECTION ON POLE. G.C. SHALL SUPPLY ENOUGH CONDUIT AND RISER HARDWARE FOR AMEREN TO EXTEND SERVICE RISER UP POLE TO SERVICE CONNECTION POINT. REFER TO AMEREN ELECTRIC SERVICE MANUAL FOR REQUIREMENTS.
- 4. ALL CONDUIT WILL BE EQUIPPED WITH 3/8" PULL ROPE AND HAVE A TRACER WIRE. TRACER WIRE NEEDS TO BE LAID ABOVE BURIED CONDUIT.







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www.sacw.com 847.944.1600

Γ		R	EVISIONS	
R	EV.	DATE	DESCRIPTION	INITIALS
L	A	10/25/18	ISSUED FOR REVIEW	DTC
	В	03/12/19	REVISED PER COMM.	MRL
	С	05/02/19	ADDED FOUNDATION	MRL
г		NOT FOR CO	ONSTRUCTION LINES	

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LABELED AS CONSTRUCTION SET

ELECTRICAL SEAL

LTE 1C&2C MICRO CELL BUILD 14805856 CRAN_RCHI_CHNOS_004 184197 1614 N. LINCOLN AVENUE URBANA, IL 61801

SHEET TITLE

ELECTRICAL ONE-LINE DIAGRAM


SHEET NUMBER

E1

ELECTRICAL NOTES

SCALE N.T.S.

3

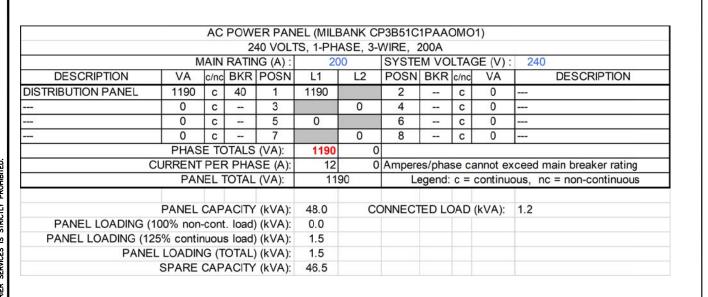

MANUFACTURER: MODEL: MILBANK CP3B51C1PAAOMO1 ELECTRICAL SPECIFICATIONS: AMPERAGE RATING: 200 A 240 V 1 PH AMPERAGE RATING:
OPERATING VOLTAGE:
ELECTRICAL PHASE:
MAIN BREAKER SIZE:
QTY OF BRANCH CIRCUITS:
LINE SIDE WIRE RANGE:


200 A 20 6 AWG - 350 kcmil ENVIRONMENT SPECIFICATIONS: UL LISTED:

NEMA RATING

ADDITIONAL SPECIFICATIONS:
ON AMEREN ENERGY APPROVED LIST (SECTION 1100 OF ELECTRIC SERVICE MANUAL, DATED JANUARY 18, 2018)



"A" Style 16" Metered Commercial Pedestal

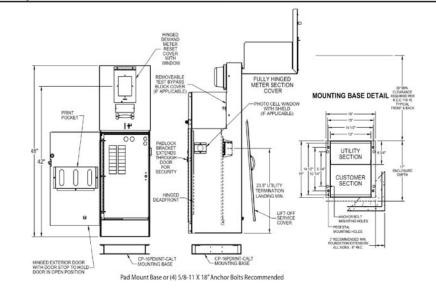

SPECIAL NOTE:
METER PEDESTAL SHALL BE PAINTED TO MATCH AT&T EQUIPMENT IN
RIGHT OF WAY. CONTRACTOR SHALL COORDINATE W/AT&T FOR COLOR
AND PROVIDE DOCUMENTATION OF SUCH TO CITY OF URBANA FOR

ELECTRICAL MAIN & LOAD CENTER PANEL SCHEDULE

SCALE N.T.S.

AC METER SOCKET W/MAIN & LOAD CENTER DETAIL

SCALE N.T.S.

AC POWER PANEL (RAYCAP RSCAC-6533-P-120-D) 120 VOLTS, 1-PHASE, 2-WIRE, 40A MAIN RATING (A) 40 SYSTEM VOLTAGE (V): DESCRIPTION VA c/nc BKR POSN L1 L2 POSN BKR c/nc VA DESCRIPTION RRUS-11 520 c SPARE 520 2 c 0 RRUS-4415 SPARE 670 c 0 7 670 4 7 C SPARE 7 0 PHASE TOTALS (VA): 520 670 CURRENT PER PHASE (A): 7 Amperes/phase cannot exceed main breaker rating PANEL TOTAL (VA): 1190 Legend: c = continuous, nc = non-continuous PANEL CAPACITY (kVA): CONNECTED LOAD (kVA): 1.2 PANEL LOADING (100% non-cont. load) (kVA): PANEL LOADING (125% continuous load) (kVA): 1.5 PANEL LOADING (TOTAL) (kVA): 1.5 SPARE CAPACITY (kVA): 3.3

MANUFACTURER: MODEL: MECHANICAL SPECIFICATIONS: HEIGHT:

WIDTH: DEPTH: WEIGHT:

10.13 IN
06.15 IN
06.00 IN
10 LBS
BANDED TO POLE W/1/2"
STAINLESS STEEL BANDING
THROUGH MANUFACTURER
SUPPLIED POLE MOUNTING
BRACKET BRACKET


-40°C TO +60°C

PTS PTS90120

ELECTRICAL SPECIFICATIONS: AMPERAGE: OPERATING VOLTAGE:
QTY OF PROTECTED CIRCUITS:

ENVIRONMENT SPECIFICATIONS: NORMAL OPERATING TEMP.:



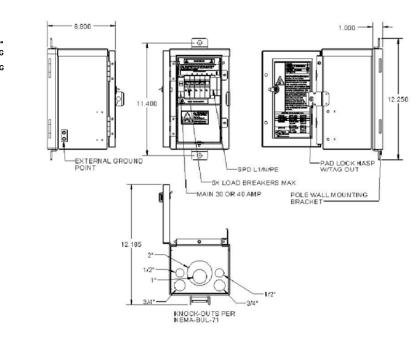





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REVISIONS									
REV.	DATE	DATE DESCRIPTION INITI							
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В	03/12/19	REVISED PER COMM.	MRL						
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ELECTRICAL SEAL

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SHEET TITLE


IPANEL SCHEDULE & ELECTRICAL DETAILS

SHEET NUMBER

4

E2

SCALE SCALE AC DISTRIBUTION PANEL DETAIL ELECTRICAL PANEL SCHEDULE N.T.S. N.T.S.

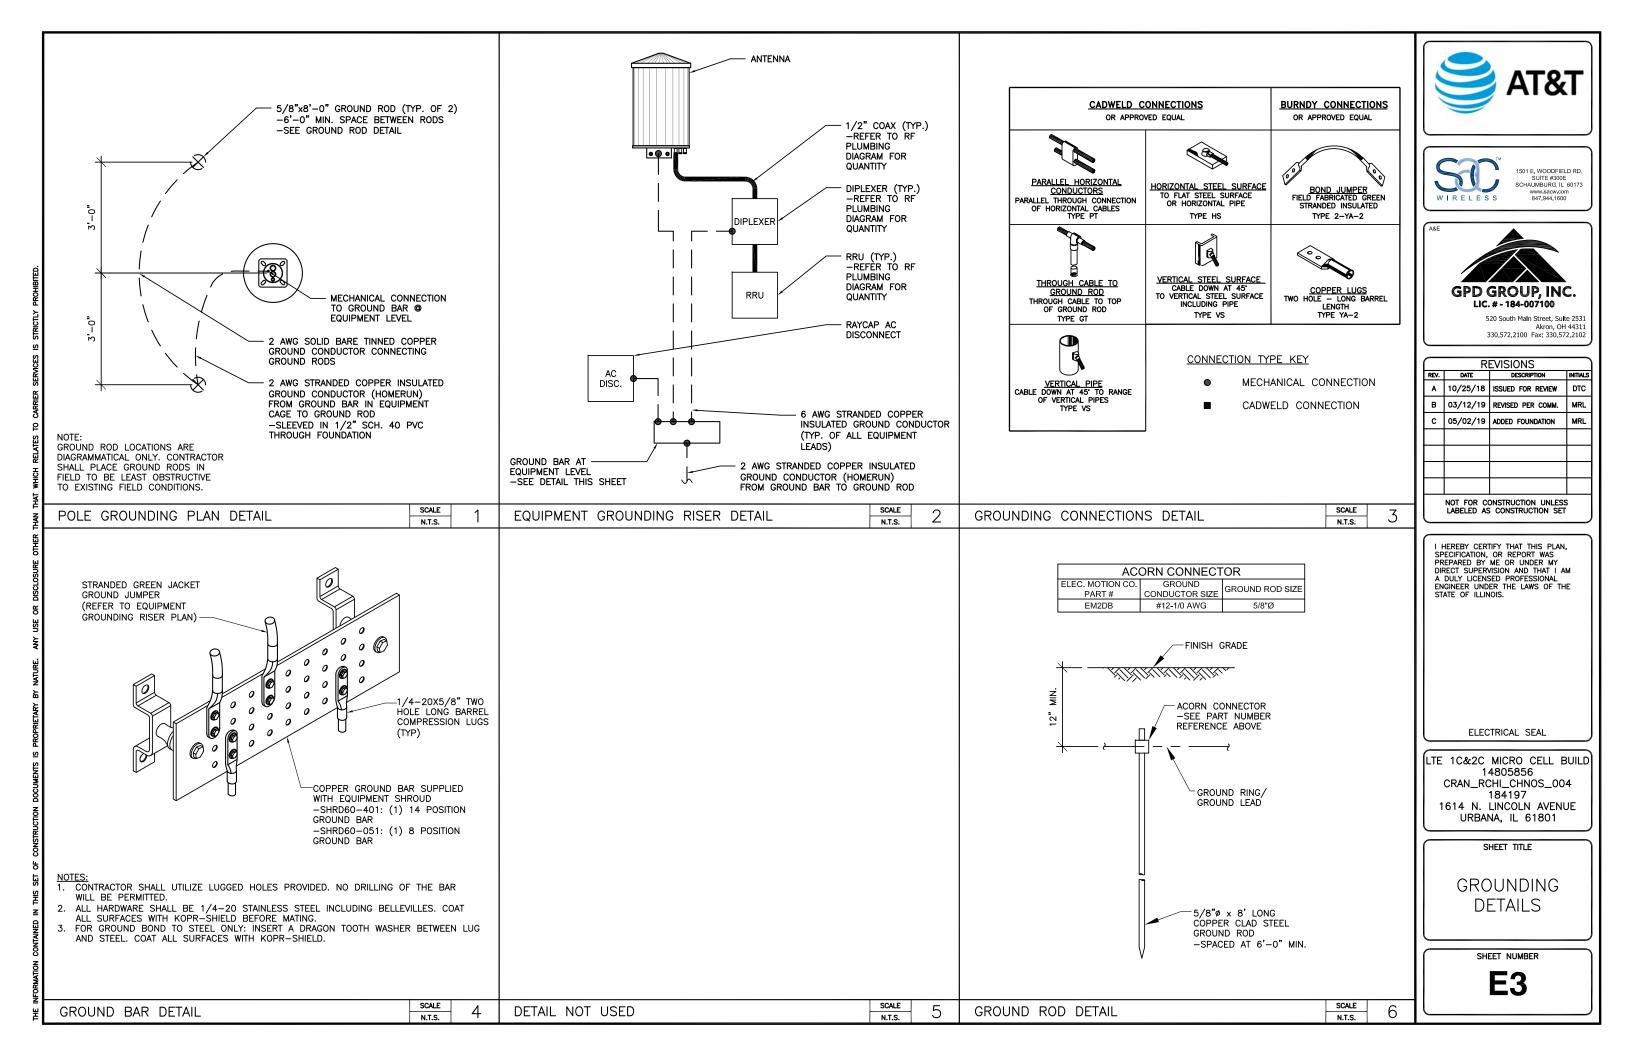


C - C 1	700 BALL-	700 B4H-	OFO BALL	OFO BALL-	4000 5411-	4000 8411-	24.00 8.411-	24.00 8.411-	EGU-144	2.5.611-	C	Contra	
Configuration Name	2T2R LTE							THE RESERVE OF THE PARTY OF THE		LAA LTE		The second second second	The second secon
	ZIZICIE	100000000000000000000000000000000000000	ZIZKLIL	14000000000	ZIZKLIL	71-1112	ZIZNEIL		755.5		Count	100000000000000000000000000000000000000	(2.7.07)(10.000)
Micro #17	Х	NA	NA	NA	NA	Х	NA	NA	NA	NA	1	2	14 Ports Antenna





Important Note:

For detailed radio to antenna wiring refer to the latest 4T4R Antenna/Radio Port Connection Field Notice (RF-HW-2016-234) and the 4T Wiring Playbook

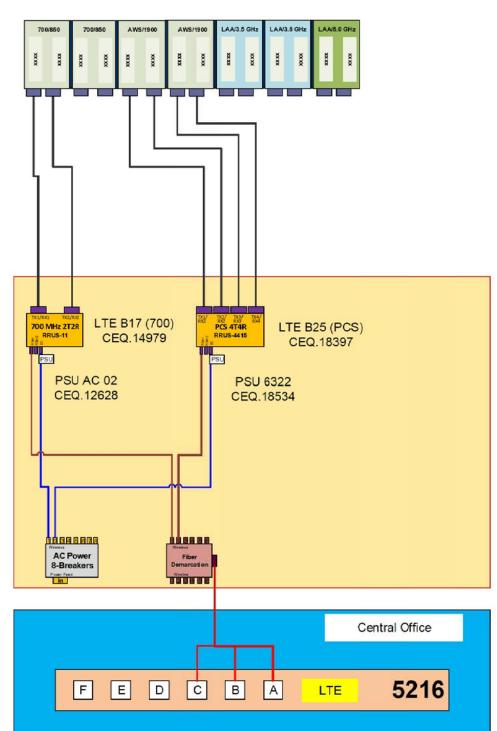





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REFERENCE ONLY

LTE 1C&2C MICRO CELL BUILD 14805856 CRAN_RCHI_CHNOS_004 184197 1614 N. LINCOLN AVENUE URBANA, IL 61801

SHEET TITLE

RF PLUMBING DIAGRAM

SHEET NUMBER

RF1


RF PLUMBING DIAGRAM

SCALE N.T.S.



ROUND TAPERED ALUMINUM Davit Arm 6' Single

Job Name:		Client Name:		
Job Location - City:	State:	Created By:	Date:	
Product:	Quote:	Customer Approval:	Date:	

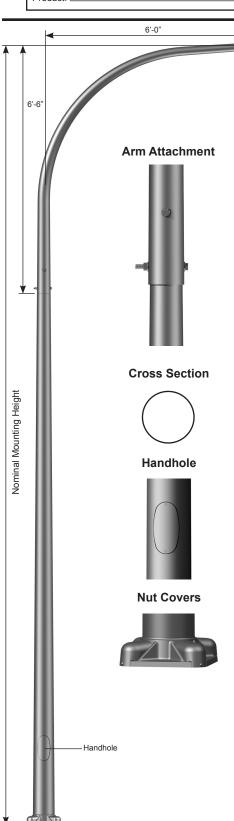

SPECIFICATIONS

Pole - The pole shaft is extruded from seamless alloy aluminum.

Davit Arm - Davit arms are conically tapered from seamless alloy aluminum to 2.38" OD at the luminaire end. Davit arm members have a 4' bend radius and a 6'-6" rise.

Davit Arm Attachment - Connection allows arm to be erected and held in place by gravity and secured by two stainless steel through bolts.

Handhole - A covered handhole with hardware and grounding provision are provided.

Base Cover - Optional decorative base covers available as special order.

Anchor Base - The anchor base is cast from 356 alloy aluminum. The completed assembly is heat-treated to a T6 temper. Aluminum nut covers are included with anchor base unless otherwise specified.

Anchor Bolts - Anchor bolts conform to ASTM F1554 Grade 55 and are provided with two hex nuts and two flat washers. Bolts have an "L" bend on one end and are galvanized a minimum of 12" on the threaded end.

Hardware - All structural and non-structural fasteners are stainless steel.

Finish - The standard finish for the pole assembly and components is satin brushed, natural anodize, duranodic or polyester powder applied coating in accordance with Valmont's Specifications. Additional finish options available upon request.

Design Criteria - Please reference Design Criteria Specification for appropriate design conditions.

ROUND TAPERED ALUMINUM Davit Arm 6' Single



Job Name:		Client Name:	
Job Location - City:	State:	Created By:	Date:
Product:	Quote:	Customer Approval:	Date:

ANCHORAGE DATA

PO	POLE		BASE	PLATE		ANCHOR BOLTS		
BASE	WALL	BOLT (CIRCLE					
OD	THK	DIA	±	SQUARE	THK		PROJECTION	±
(IN)	(IN)	(IN)	(IN)	(IN)	(IN)	(IN)	(IN)	(IN)
6.00	0.156	9.50	0.75	10.32	0.630	0.75 x 17.00 x 3.00	3.50	N/A
7.00	0.156	10.56	0.43	11.26	0.750	1.00 x 36.00 x 4.00	4.13	N/A
8.00	0.156	11.63	0.37	12.05	0.750	1.00 x 36.00 x 4.00	4.13	N/A
8.00	0.188	11.63	0.37	12.05	0.750	1.00 x 36.00 x 4.00	4.13	N/A
8.00	0.250	11.63	0.37	12.05	0.750	1.00 x 36.00 x 4.00	4.13	N/A
9.00	0.156	13.25	0.75	12.48	1.250	1.00 x 36.00 x 4.00	4.13	N/A
9.00	0.188	13.25	0.75	12.48	1.250	1.00 x 36.00 x 4.00	4.13	N/A

Anchor Base Detail 180° Bolt Slots/Holes Bolt Circle As viewed from top of pole. Arm 1 0° - Handhole

LOAD AND DIMENSIONAL DATA

DESIGN INFORMATION					POLE DIMENSIONS								
			70 MPH w/1.3 GUST	80 MPH w/1.3 GUST	90 MPH w/1.3 GUST	100 MPH w/1.3 GUST	110 MPH w/1.3 GUST						
NOMINAL		MAX	MAX	MAX	MAX	MAX	MAX		BASE	TOP	WALL	STRUCTURE	
MOUNTING	QUANTITY	WEIGHT1	EPA ¹	EPA ¹	EPA ¹	EPA ¹	EPA ¹	POLE	OD	OD	THK	WEIGHT ²	MODEL
HEIGHT	OF ARMS	(LBS)	(SQ FT)	(SQ FT)	(SQ FT)	(SQ FT)	(SQ FT)	HEIGHT	(IN)	(IN)	(IN)	(LBS)	NUMBER
20'-0"	Single	75	6.0	6.0	6.0	4.7	3.4	13'-6"	6.00	4.00	0.156	69	200065106D4Z
25'-0"	Single	75	6.0	5.2	3.3	2.0	1.1	18'-6"	6.00	4.00	0.156	83	250065106D4Z
25-0	Sirigle	75	6.0	6.0	6.0	4.5	3.2	18-'6"	7.00	4.00	0.156	91	250075106D4Z
		75	4.5	2.3	0.8	N/A	N/A	23'-6"	6.00	4.00	0.156	98	300065106D4Z
30'-0"	Single	75	6.0	5.4	3.4	2.0	1.0	23'-6"	7.00	4.00	0.156	109	300075106D4Z
		75	6.0	6.0	6.0	4.4	2.9	23'-6"	8.00	4.50	0.156	122	300085106D4Z
		75	5.0	2.5	1.0	N/A	N/A	28'-6"	7.00	4.00	0.156	124	350075106D4Z
		75	6.0	5.5	3.4	2.0	0.9	28'-6"	8.00	4.50	0.156	139	350085106D4Z
35'-0"	Single	75	6.0	6.0	5.3	3.5	2.2	28'-6"	8.00	4.50	0.188	160	350086106D4Z
] 33-0	Single	75	6.0	6.0	6.0	4.2	2.7	28'-6"	9.00	4.50	0.156	153	350095106D4Z
		75	6.0	6.0	6.0	6.0	4.3	28'-6"	9.00	4.50	0.188	176	350096106D4Z
		75	6.0	6.0	6.0	6.0	4.6	28'-6"	8.00	4.50	0.250	200	350088106D4Z
		75	5.2	2.6	1.1	N/A	N/A	33'-6"	8.00	4.50	0.156	159	400085106D4Z
	75	6.0	4.6	2.7	1.3	N/A	33'-6"	8.00	4.50	0.188	183	400086106D4Z	
40'-0"	Single	75	6.0	5.6	3.5	1.9	0.8	33'-6"	9.00	4.50	0.156	175	400095106D4Z
		75	6.0	6.0	5.5	3.6	2.1	33'-6"	9.00	4.50	0.188	202	400096106D4Z
		75	6.0	6.0	5.7	3.8	2.3	33'-6"	8.00	4.50	0.250	231	400088106D4Z

- 1. EPA represents the Effective Projected Area of each luminaire. Designs are limited to one luminaire per arm. Variations from sizes above are available upon inquiry at the factory. Satisfactory performance of poles is dependent upon the pole being properly attached to a supporting foundation of adequate design.
- 2. Structure weight is a nominal value which includes the pole shaft, base plate and luminaire arm(s).

PRODUCT ORDERING CODES

CROSS SECTION	MODEL NUMBER	СО	LOR	OPTIONS
R = Round	200065106D4Z 250065106D4Z 250075106D4Z 300065106D4Z 300075106D4Z 300085106D4Z 350085106D4Z 350086106D4Z 350086106D4Z 350086106D4Z 350096106D4Z 400085106D4Z 400085106D4Z 400085106D4Z 400095106D4Z 400096106D4Z 400098106D4Z	Polyester Powder DWH = White DSS = Sandstone BR = Burgundy HG = Hunter Green DNA = Natural Aluminum DCG = Charcoal Gray DMB = Medium Bronze SBN = Sanded Brown DNB = New Dark Bronze DBB = Dark Bronze SBK = Sanded Black DBL = Black DSB = Steel Blue DTG = Dark Green DBR = Red SC = Special Color (Contact Factory)	Anodized 204 = Clear Natural 311 = Light Bronze* 312 = Medium Bronze* 313 = Dark Bronze* 335 = Black* *Duranodic Anodize Brushed SBF = Satin Brushed	See Accessories at valmontstructures.com (Please Specify with Code)

SITE NAME: COUNTY: ADDRESS:

FA NUMBER:

CRAN_RCHI_CHUOI_015 CHAMPAIGN 402 W. SPRINGFIELD AVENUE

JURISDICTION

URBANA, IL 61801 CITY OF URBANA 14805800

3304A0AAPA / 3304A0AARW MRCHI025457 / MRCHI025418

LATITUDE: LONGITUDE: **ELEVATION:**

40° 06' 44.23" (40.112286°) 88° 12′ 43.13″ (-88.211981°)

LIGHT POLE/UTILITY POLE OWNÉR:

CITY OF URBANA

APPLICANT:

AT&T MOBILITY 930 NATIONAL PARKWAY SCHAUMBURG IL 60173

AT&T_PROJECT MANAGER/SITE

ACQUISITION:

VANESSA ROSS (217) 814-2314 VF2021@ATT.COM

AT&T CONSTRUCTION

MANAGER:

CHRISTIANA RACHAL CR630A@ATT.COM

PROJECT CONSULTANTS

PROJECT MANAGER: SAC WIRELESS LLC

540 W. MADISON ST. (9TH FLOOR) CHICAGO IL 60661 CONTACT: PRITI MORE PHONE: (312) 789-4353 EMAIL: PRITI.MORE@SACW.COM

GPD GROUP, INC. — 184—007100 520 S. MAIN ST., SUITE 2531 AKRON, OH 44311 ARCHITECT:

JAMES HOM

SAC C.M. MARK KLEPACKI

EMAIL: MARK.KLEPACKI@SACW.COM

SAC P.M.

EMAIL: JAMES.HOM@SACW.COM

AT&T MOBILITY

PROJECT: LTE 1C&2C MICRO CELL BUILD

SITE #: CRAN_RCHI_CHUOI_015

USID / NODE: 184220 FA #: 14805800

PTN #: 3304A0AAPA / 3304A0AARW PACE #: MRCHI025457 / MRCHI025418

ENODEB NAME: ILL07045F_R02 JURISDICTION: CITY OF URBANA

SITE NAME: CRAN_RCHI_CHUOI_015

402 W. SPRINGFIELD AVENUE **ADDRESS:**

URBANA, IL 61801

VICINITY MAP LOCATION MAP NOT TO SCALE



DRAWING INDEX TITLE SHEET FIBER DELIVERY PLANS (REFERENCE ONLY) A2 OVERALL SITE PLAN Α3 ENLARGED PLAN **FXISTING LIGHT POLE FLEVATION** A5 PROPOSED LIGHT POLE ELEVATIONS A6 EQUIPMENT DETAILS (REFERENCE ONLY) Α7 MOUNTING DETAILS S1 POLE FOUNDATION DETAILS ELECTRICAL ONE-LINE DIAGRAM E2 PANEL SCHEDULE & ELECTRICAL DETAILS E3 GROUNDING DETAILS RF1 RF PLUMBING DIAGRAM (REFERENCE ONLY) POLE MANUFACTURER DESIGN (BY OTHERS)

SCOPE OF WORK

THIS IS NOT AN ALL INCLUSIVE LIST. CONTRACTOR SHALL UTILIZE SPECIFIED EQUIPMENT PART OR ENGINEER APPROVED EQUIVALENT. CONTRACTOR SHALL VERIFY ALL NEEDED EQUIPMENT TO PROVIDE A FUNCTIONAL SITE. THE PROJECT GENERALLY CONSISTS OF THE FOLLOWING:

- REMOVE EXISTING LIGHT POLE AND REPLACE WITH NEW 40'-0" HAPCO
- ALUMINUM RTA DAVIT ARM LIGHT POLE (BLACK POWDER COAT 5 YR)
 INSTALL NEW ELECTRIC SERVICE RUN FROM EXISTING SOURCE TO NEW LIGHT POLE. METER SUPPLIED & INSTALLED BY CONTRACTOR.
 INSTALL NEW FIBER SERVICE RUN FROM EXISTING SOURCE TO NEW LIGHT
- POLE LOCATION AS SHOWN.
- INSTALL NEW POWER & FIBER EQUIPMENT PER PLAN
- INSTALL (1) NEW OMNI ANTENNA
- INSTALL (1) PCS RRUS-4415 & (1) 700 RRUS-11
- INSTALL CABLING AS REQUIRED
- GROUND AS REQUIRED LIGHT POLE LUMINARY TO BE SUPPLIED & INSTALLED BY CONTRACTOR.
- LUMINARY MUST BE APPROVED BY CITY OF URBANA PRIOR TO ORDER. STREET LIGHTING HANDHOLE (IF REQUIRED) SUPPLIED & INSTALLED BY
- CONTRACTOR POTHOLING SHALL BE REQUIRED FOR ANY PROPOSED UTILITY CROSSING HYDROVAC SHALL BE USED FOR ALL TRENCHING & POTHOLING ACTIVITIES
- CONTRACTOR SHALL MAINTAIN INTEGRITY OF EXISTING POLE DURING REMOVAL & COORDINATE RETURN OF REMOVED POLE TO THE CITY OF URBANA

UTILITY DELIVERY METHOD TO PROPOSED POLE

FIBER - UNDERGROUNDPOWER - UNDERGROUND

CODE COMPLIANCE

- 2015 INTERNATIONAL BUILDING CODE W/CITY AMMENDMENTS
- 2014 NATIONAL ELECTRIC CODE W/CITY AMMENDMENTS

SPECIAL NOTES

- ALL WORK SHALL BE INSTALLED IN CONFORMANCE WITH CURRENT AT&T CONSTRUCTION INSTALLATION GUIDE.
- EXISTING CONDITIONS WILL BE CHANGED & VERIFIED IN FIELD. IF SIGNIFICANT DEVIATIONS OR DETERIORATION ARE ENCOUNTERED AT THE TIME OF CONSTRUCTION, A REPAIR PERMIT WILL BE OBTAINED & CONTRACTOR SHALL NOTIFY ENGINEER IMMEDIATELY.
- THESE DRAWINGS ARE FULL SIZE & SCALEABLE ON 11"X17" SHEET SIZE. STATEMENT THAT COMPLIANCE WITH THE ENERGY CODE IS NOT REQUIRED. -SCOPE OF WORK DOES NOT INVOLVE MODIFICATIONS TO EXTERIOR ENVELOPE OF BUILDING, HVAC SYSTEMS OR ELECTRICAL LIGHTING

DO NOT SCALE DRAWINGS

CONTRACTOR SHALL VERIFY ALL PLANS & EXISTING DIMENSIONS & CONDITIONS ON THE JOB SITE & SHALL IMMEDIATELY NOTIFY THE ARCHITECT OR ENGINEER IN WRITING OF ANY DISCREPANCIES BEFORE PROCEEDING WITH THE WORK OR BE RESPONSIBLE FOR SAME.









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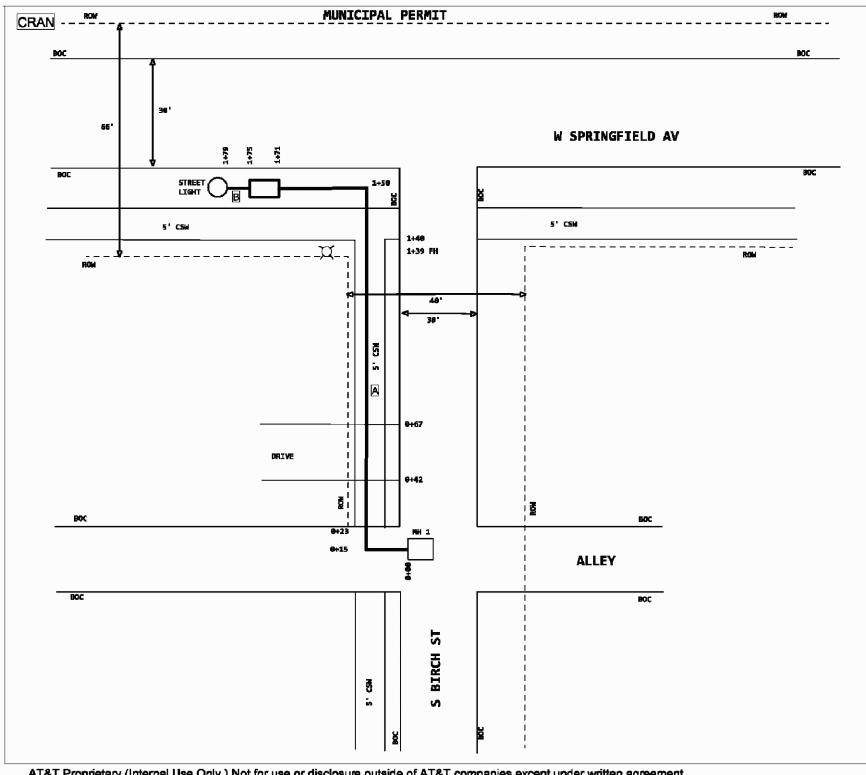
LTE 1C&2C MICRO CELL BUILD 14805800 CRAN_RCHI_CHUOI_015 184220 402 W. SPRINGFIELD AVENUE URBANA, IL 61801


SHEET TITLE

TITLE SHEET

SHFFT NUMBER

SAC File: T:\ATandT\184220\01 2017732 49 SAC\AE\CD\CRAN_RCHI_CHUOI_015 URBANA CD.dwg 05/02/19 13:48



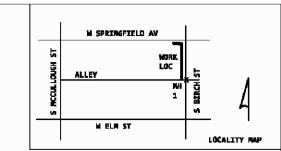

CONSTRUCTION NOTES:

1. CALL LOCATOR 4B HOURS BEFORE DIGGING.
2. RESTORE ALL DISTURBED GROUND TO ORIGINAL OR BETTER CONDITION.
3. MINOR ADJUSTMENTS TO AVOID FACILITIES

WHILE PLACING APPROVED.

4. CONTRACTOR TO PLACE COMBUIT NO LESS THAN 24" DEPTH.
5. PROVIDE ALL BARRICADES AND WORK PROTECTION.

6. REMOVE ALL DEBRIS.
7. DA IS AN ESTABLISHED AREA WITH FENCES,

SHEDS, ETC. TURNEL ALL TREES & LANDSCAPING PER VILLAGE GUIDELINES, 8. ALL PROPOSED WORK IN THE EXISTING PUBLIC

RIGHT OF WAY OR UTILITY EASEMENT.

JGB SUMMARY: AT&T CONTRACTOR TO CORE BORE MH

A DIRECTIONAL BORE 171'
AND PLC 1 - 1 1/4' IPP

B HAND DIG 4'

PLC 1 - 10" X 15" X 12" HANDHOLE

> MUNICIPAL PERMIT 201 S NEIL ST, FLR 1 CHAMPAIGN, IL 61820

PROJECT # A01CS98 ENGR: MURPHY, MICHAEL S PHONE #: 2173987979 MUNICIPALITY: Urbana COUNTY: Champaign TOWNSHIP: Urbana QUARTER SECTION: NM 17

PRINT 1 OF 1

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	REVISIONS					
REV.	DATE	DESCRIPTION	INITIALS			
A	10/30/18	ISSUED FOR REVIEW	DTC			
В	03/12/19	REVISED PER COMM	MRL			
С	05/02/19	ADDED FOUNDATION	MRL			

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REFERENCE ONLY

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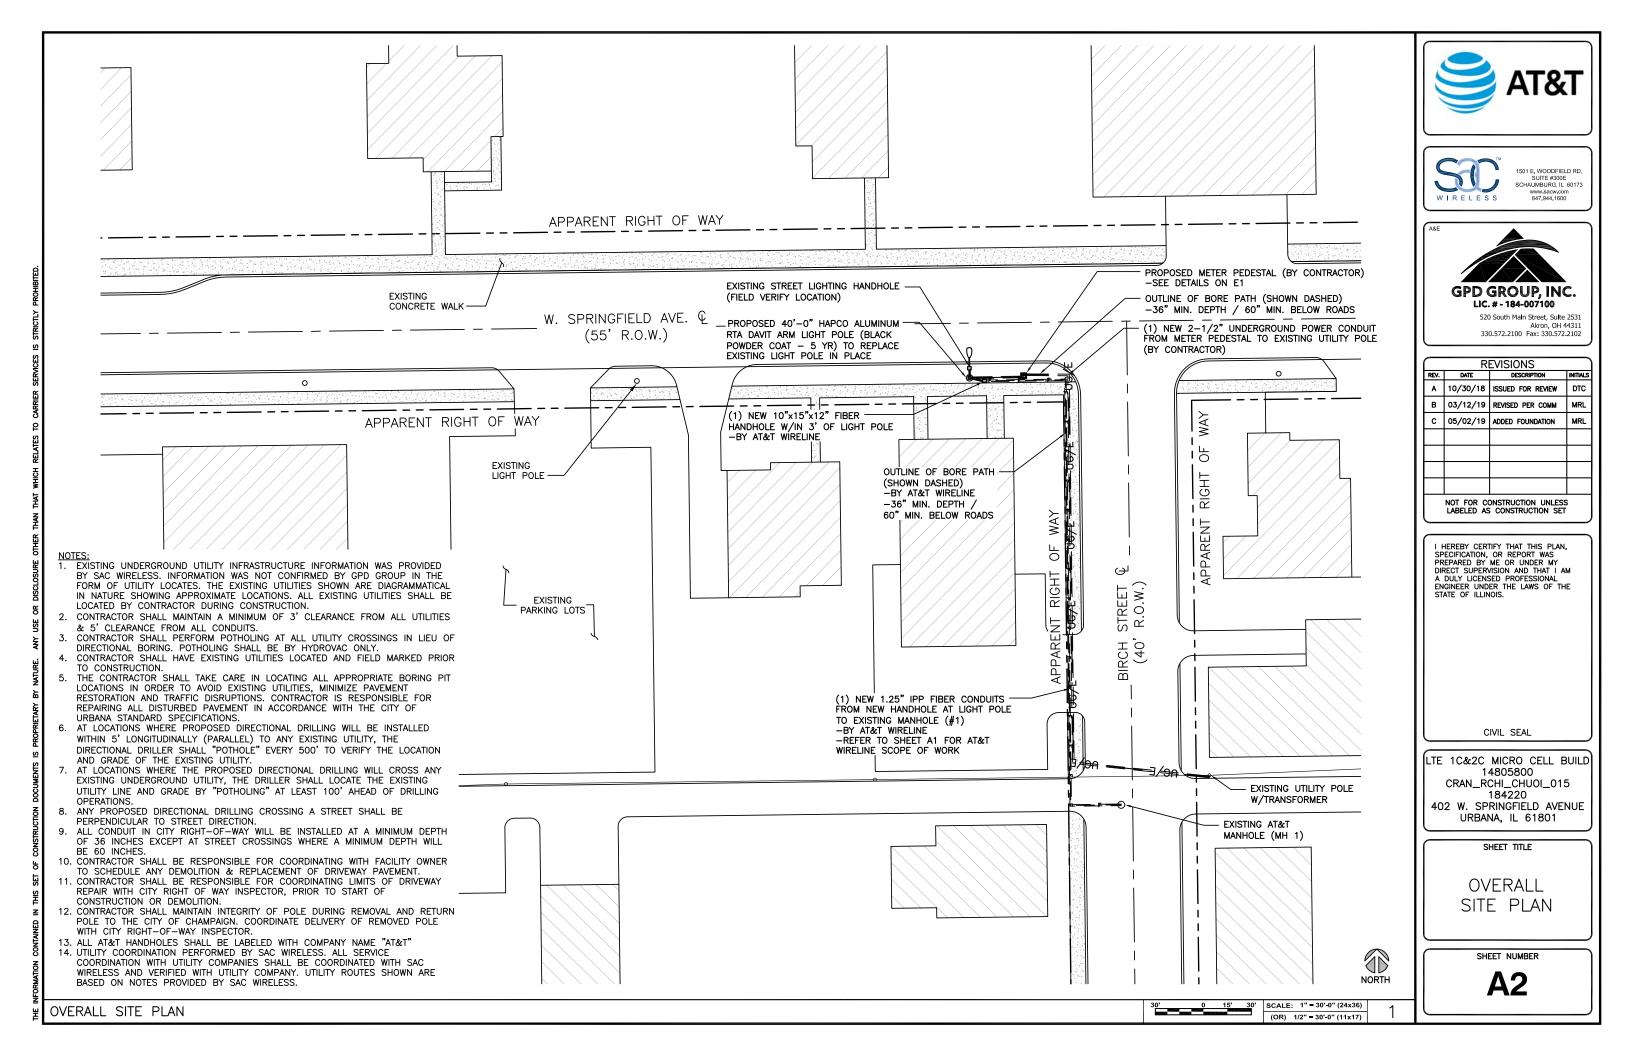
SHEET TITLE


FIBER DELIVERY PLANS

SHEET NUMBER

A1

SCALE FIBER DELIVERY PLANS N.T.S.



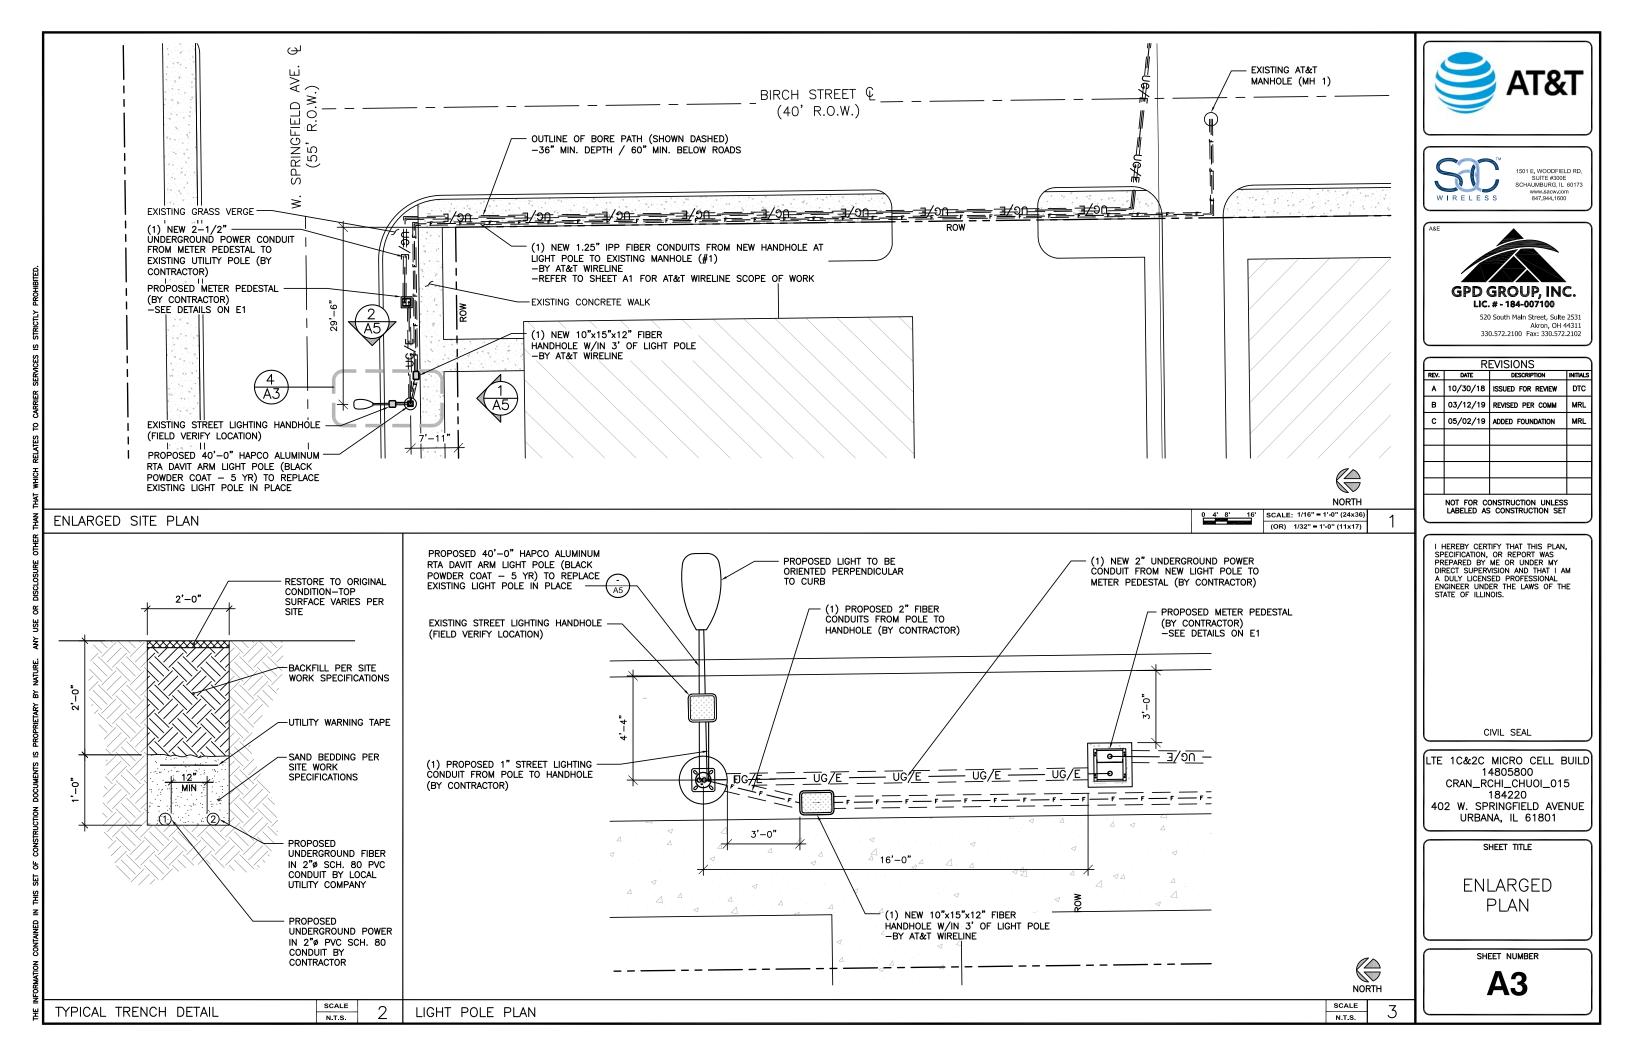







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CIVIL SEAL


LTE 1C&2C MICRO CELL BUILD 14805800 CRAN_RCHI_CHUOI_015 184220 402 W. SPRINGFIELD AVENUE URBANA, IL 61801

SHEET TITLE

EXISTING LIGHT POLE ELEVATION

SHEET NUMBER

A4

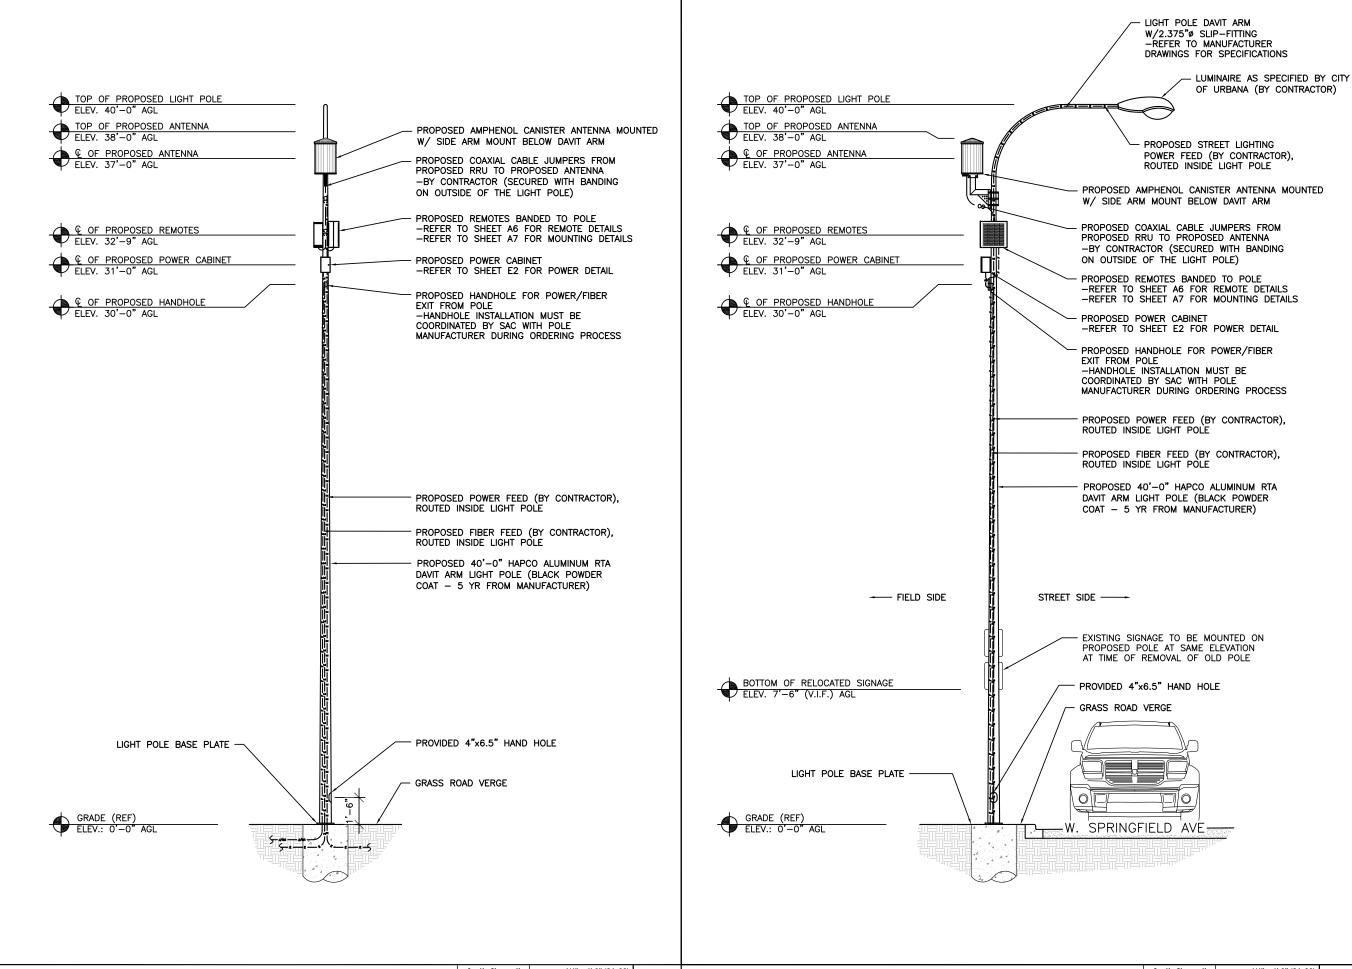







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	R	EVISIONS	
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В	03/12/19	REVISED PER COMM	MRL
С	05/02/19	ADDED FOUNDATION	MRL
	NOT FOR CO	ONSTRUCTION LINES	

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LABELED AS CONSTRUCTION SET

CIVIL SEAL

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SHEET TITLE

PROPOSED LIGHT POLE **ELEVATIONS**

SHEET NUMBER

A5

SCALE: 1/4" = 1'-0" (24x36) PROPOSED LIGHT POLE SIDE ELEVATION (OR) 1/8" = 1'-0" (11x17)

SCALE: 1/4" = 1'-0" (24x36)


MANUFACTURER: MODEL: MECHANICAL SPECIFICATIONS: HEIGHT: WEIGHT: EXTERNAL ALARMS:

ERICSSON RRUS 4415 B25

14.96 IN (380mm) 13.19 IN (335mm) 5.39 IN (137mm) 46 LBS (21kg)

INTERFACE SPECIFICATIONS: CPRI:

2x2.5/4.9/9.8/10.1 Gbps (ONLY USE ERICSSON SUPPLIED AND APPROVED SFPs) 2

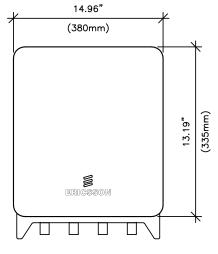



MANUFACTURER: MODEL: ERICSSON RRUS-11

MECHANICAL SPECIFICATIONS: HEIGHT: WIDTH: DEPTH: WEIGHT:


19.7 IN (500mm) 17.0 IN (431mm) 7.2 IN (182mm) 50.7 LBS (23kg)

-48 VDC OR 100-250 VAC

INTERFACE SPECIFICATIONS: ANTENNA PORTS: OPTICAL INDICATORS: EXTERNAL ALARMS: FIELD GROUND: 2x7/16 IEC-169-4

ELECTRICAL SPECIFICATIONS: POWER SUPPLY:


ENVIRONMENTAL SPECIFICATIONS: NORMAL OPERATING TEMP.: RELATIVE HUMIDITY: -40°C TO +55°C 5-100%

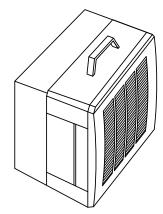




SCALE SCALE RRUS 4415 B25 DETAILS RRUS-11 DETAILS N.T.S. N.T.S.



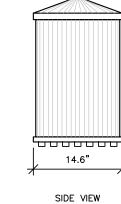

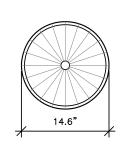

TOP VIEW

AMPHENOL MULTI BAND CANISTER ANTENNA MODEL: 2C2U3MT360X06Fxys0 COLOR: GREY

MECHANICAL CHARACTERISTICS

- ANTENNA DIMENSIONS (HEIGHT X DIAMETER):
- WEIGHT W/OUT MOUNTING BRACKET KIT:
- SURVIVAL WIND SPEED:
- WIND AREA:
- WIND LOAD (100 MPH):

24.0"x14.6" TBD LBS 150 MPH 2.4 FT² 43 LBF





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I	REV.	DATE	DESCRIPTION	INITIAL
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SHEET TITLE

EQUIPMENT DETAILS

SHEET NUMBER


A6

IMAGE

SCALE DETAIL NOT USED ANTENNA DETAIL N.T.S.


SCALE: NTS

4

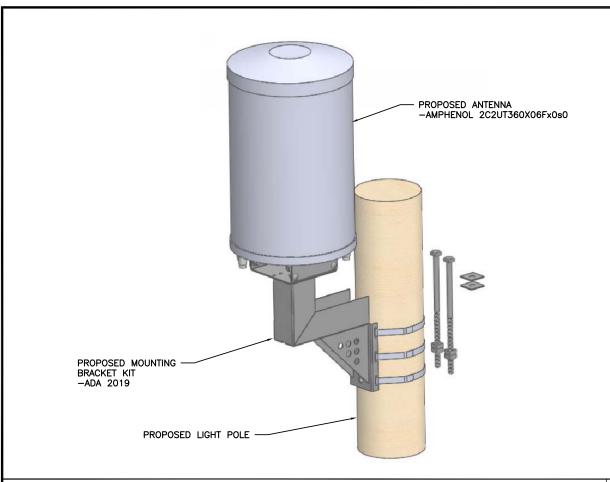

ANTENNA MOUNTING DETAIL

SCALE

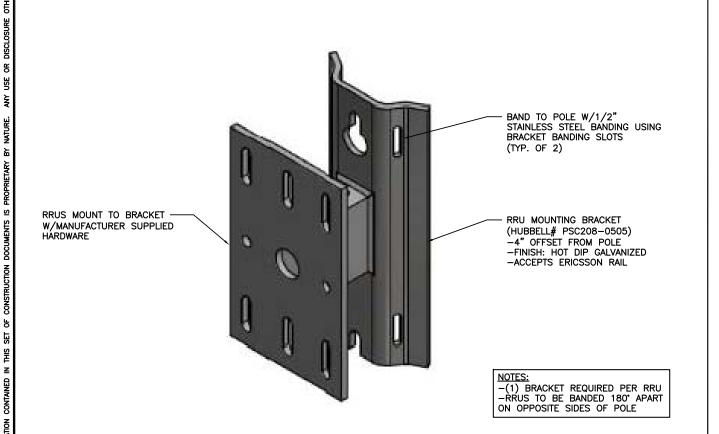


EXAMPLE CRAN RF CAUTION SIGN

A CAUTION A AT&T operates antennas at this structure Above this point you are entering an area where radio frequency (RF) fields may exceed the FCC General Occupational Exposure limits. Follow safety guidelines for working in an RF environment Keep 1 ft. away from the fronts of

Contact AT&T at 800-638-2822, opt. 9, 3 and follow their instructions prior to performing any maintenance or repairs above this point.

Cell Site USID.

EXAMPLE CRAN RF NOTICE SIGN

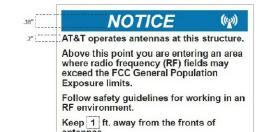

Contact AT&T at 800-638-2822, opt. 9, 3 and follow their instructions prior to performing any maintenance or repairs above this point.

This is AT&T Site USID_

EXAMPLE CRAN POLE POWER DISCONNECT SIGN

DISCONNECT AC & DC POWER BOTH BEFORE WORKING ON POLE Contact AT&T at 800-638-2822,

opt. 9, 3 and follow their instructions prior to performing any maintenance or repairs above this point. Cell Site USID

EXAMPLE STONEHOUSE RD899 RF NOTICE SIGN

NOTICE

RF energy emitted by this antenna may exceed the FCC's exposure limits for the general population.

Stay at least 1 feet away from the antenna.

Call AT&T at 800-638-2822, option 9 then 3, for help if you need access within 3 feet.

STONEHOUSE RD899

CRAN Pole Power Disconnect, RF Notice, and Caution signs shall be ordered through Stonehouse Signs. Three versions are available for each of the signs shown in Figures 16, 17, and 18: .055 Polyethylene – Reflective, .025 Aluminum – Reflective, and Peel Back Label – Reflective. All versions are 6°x6" with font designed to be visible from 2-3 feet away when approached from below to provide warning about ascending into the high RF exposure areas. The RF Caution sign shown in Figure 19 is designed to be visible from 3 feet away and is available in the reflective peel back label version only. It is designed to fit on most of the CRAN/Small Cell antenna types currently deployed. It may also be placed on antenna shrouds as shown in Figures 11 and 12.

SIGNAGE NOTE:
SIGNAGE SHALL BE INSTALLED PER AT&T DIRECTION



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CIVIL SEAL

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SHEET TITLE

MOUNTING DETAILS

SHEET NUMBER


A7

SCALE RRU MOUNTING DETAIL AT&T SIGNAGE DETAIL N.T.S.

SCALE: NTS

16.5 pt.

3

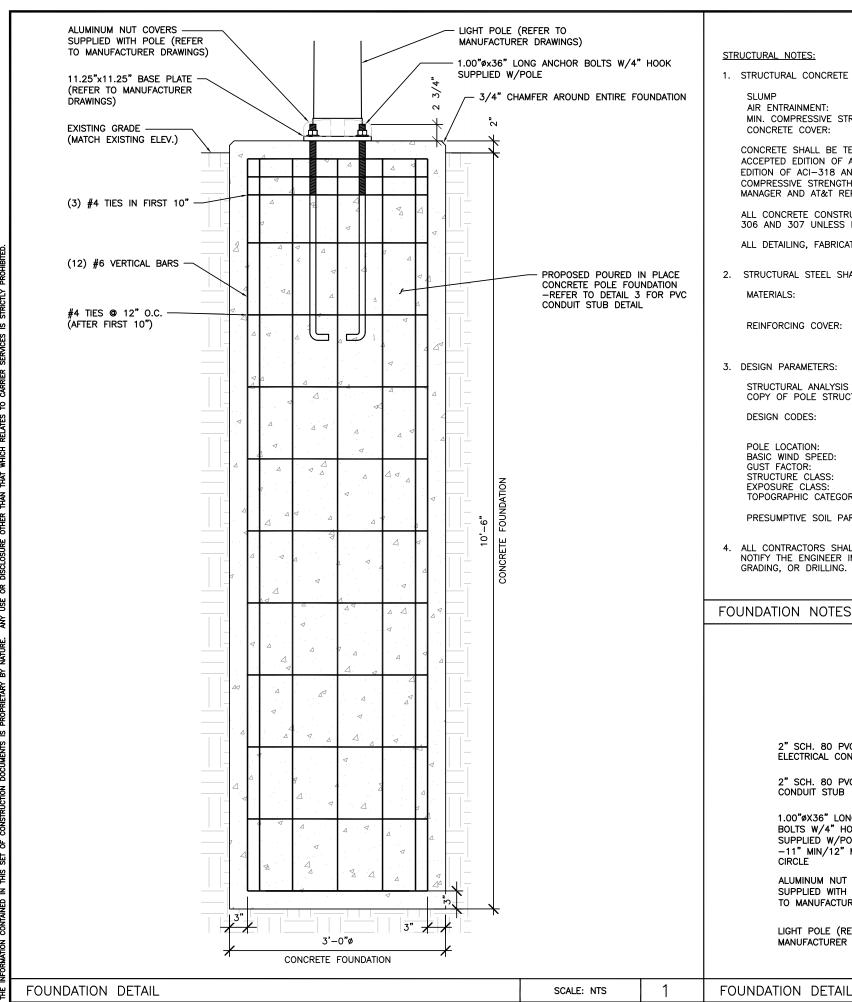

STRUCTURAL NOTES:

1. STRUCTURAL CONCRETE SHALL MEET THE FOLLOWING SPECIFICATIONS:

 $4" (\pm 1")$ AIR ENTRAINMENT: 6% (±1%) MIN. COMPRESSIVE STRENGTH (F'c): 4,500 PSI @ 28 DAYS CONCRETE COVER: 3" ALL SIDES

CONCRETE SHALL BE TESTED BY A REPUTABLE INDEPENDENT THIRD PARTY TESTING AGENCY IN ACCORDANCE WITH LATEST WISCONSIN ACCEPTED EDITION OF ACI-318. FIVE (5) CONCRETE CYLINDERS SHALL BE CAST IN ACCORDANCE WITH LATEST WISCONSIN ACCEPTED EDITION OF ACI-318 AND BE LABORATORY CURED. THE AVERAGE OF THREE (3) CONCRETE CYLINDERS SHALL HAVE A MINIMUM COMPRESSIVE STRENGTH (F'c) OF 4,500 PSI AT 28 DAYS. THE TESTING RESULTS SHALL BE PROVIDED TO THE CONSTRUCTION MANAGER AND AT&T REPRESENTATIVE.

ALL CONCRETE CONSTRUCTION SHALL CONFORM TO ACI*96, "STANDARD SPECIFICATION FOR STRUCTURAL CONCRETE" AND ACI 305, 306 AND 307 UNLESS NOTED OTHERWISE.

ALL DETAILING, FABRICATION AND PLACING OF CONCRETE SHALL CONFORM TO ACI 318-11.

2. STRUCTURAL STEEL SHALL MEET THE FOLLOWING SPECIFICATIONS:

REINFORCING ASTM 615, GRADE 60 MATERIALS: ANCHOR BOLTS ASTM F1554, GRADE 55

REINFORCING COVER: TOP воттом 3"

3. DESIGN PARAMETERS:

STRUCTURAL ANALYSIS OF THE POLE AND FOUNDATION WAS COMPLETED BY OTHERS. COORDINATE WITH SAC WIRELESS FOR A COPY OF POLE STRUCTURAL ANALYSIS.

DESIGN CODES: 2015 INTERNATIONAL BUILDING BUILDING CODE

TIA-222-G

POLE LOCATION: CHAMPAIGN COUNTY, IL

BASIC WIND SPEED: GUST FACTOR: 130 MPH 1.14 STRUCTURE CLASS: CLASS II

MANUFACTURER DRAWINGS)

EXPOSURE CLASS: TOPOGRAPHIC CATEGORY:

PRESUMPTIVE SOIL PARAMETERS: FOUNDATION IS BASED ON AN ALLOWABLE LATERAL BEARING PRESSURE OF AT LEAST 200 PSF/FT.

4. ALL CONTRACTORS SHALL EXERCISE GREAT CARE DURING EXCAVATION. CONTRACTOR SHALL PREDETERMINE UTILITY LOCATIONS AND NOTIFY THE ENGINEER IMMEDIATELY IF DEVIATION FROM PLANS EXIST. CONTRACTOR SHALL CONTACT 811 48 HR. PRIOR TO DIGGING, GRADING, OR DRILLING.

FOUNDATION NOTES

3'-0"ø REINFORCED CONCRETE FOUNDATION 2" SCH. 80 PVC LIGHTING 2" SCH. 80 PVC FIBER ELECTRICAL CONDUIT STUB CONDUIT STUB 2" SCH. 80 PVC ELECTRIC CONDUIT STUB 1.00"øX36" LONG ANCHOR BOLTS W/4" HOOK 1/2" SCH. 80 PVC SUPPLIED W/POLE GROUNDING CONDUIT STUB -11" MIN/12" MAX BOLT CIRCLE ALUMINUM NUT COVERS -SUPPLIED WITH POLE (REFER 11.25"X11.25" BASE PLATE TO MANUFACTURER DRAWINGS) (REFER TO MANUFACTURER DRAWINGS) LIGHT POLE (REFER TO





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С	05/02/19	ADDED FOUNDATION	MRL				
	•		•				

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SCALE

N.T.S.

2

3

SCALE: NTS

STRUCTURAL SEAL


LTE 1C&2C MICRO CELL BUILD 14805800 CRAN_RCHI_CHUOI_015 184220 402 W. SPRINGFIELD AVENUE URBANA, IL 61801


SHEET TITLE

POLE **FOUNDATION** DETAILS

SHEET NUMBER

S1

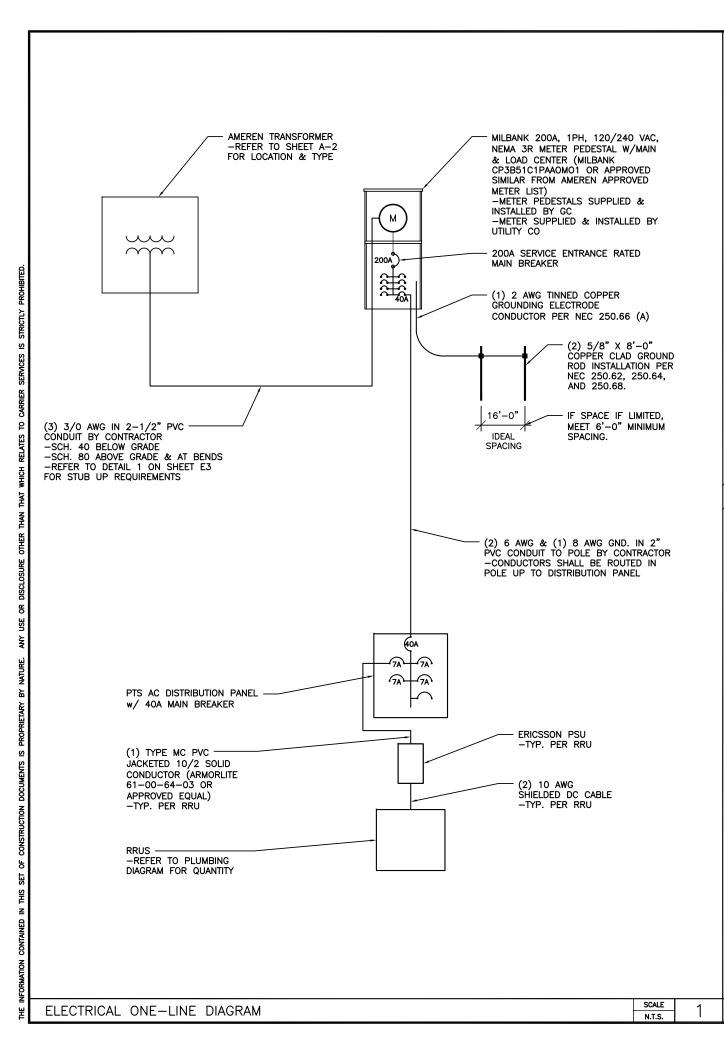

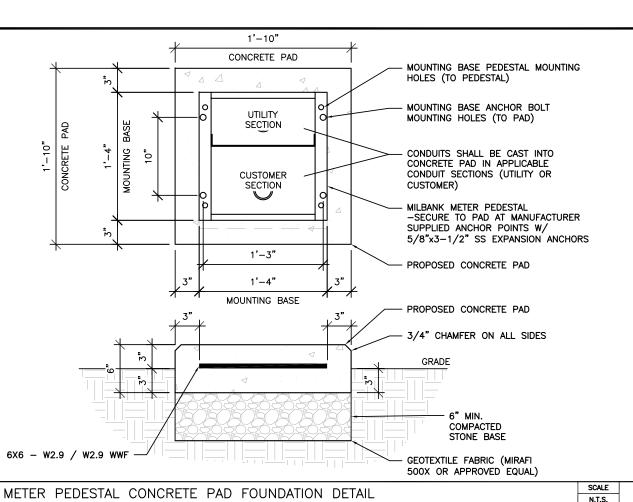

ELECTRICAL NOTES:

1. ALL ELECTRICAL WORK SHALL BE IN ACCORDANCE WITH THE PROJECT SPECIFICATIONS AND ALL APPLICABLE CODES.

2. CONDUIT ROUTINGS ARE SCHEMATIC. SUBCONTRACTOR SHALL INSTALL CONDUITS SUCH THAT ACCESS TO EQUIPMENT IS NOT BLOCKED.

3. SUBCONTRACTOR IS RESPONSIBLE FOR PROPERLY SEQUENCING THE INSTALLATION OF GROUNDING AND UNDERGROUND CONDUIT AS TO PREVENT THE LOSS OF CONTINUITY IN THE GROUNDING SYSTEM OR DAMAGE TO THE CONDUIT.

4. COMPRESSION GROUND CONNECTIONS MAY BE REPLACED BY EXOTHERMIC (CADWELD) CONNECTIONS WHEN APPROVED BY CINCINNATI BELL CONSTRUCTION MANAGER.

5. SERVICE TO METER PEDESTAL SHALL BE 120/240VAC, 200 AMP, SINGLE PHASE.

- 6. ALL GROUND CONNECTIONS BELOW GRADE SHALL BE EXOTHERMIC (CADWELD).
- 7. ALL GROUND CONNECTIONS ABOVE GRADE SHALL BE FORMED USING TWO (2) HIGH PRESS CRIMPS.
- ALL EXOTHERMIC CONNECTIONS TO THE GROUND RODS SHALL START AT THE TOP AND HAVE A VERTICAL SEPARATION OF 6" FOR EVERY ADDITIONAL CONNECTION.
- 9. ALL EXTERIOR GROUND CONNECTIONS SHALL BE COATED WITH A CORROSION RESISTANT MATERIAL.
- 10. ALL EXTERIOR GROUND CONNECTORS SHALL BE 2 AWG SOLID BARE, TINNED, COPPER UNLESS INDICATED OTHERWISE.
- 11. CONNECTIONS TO THE GROUND BUS SHALL NOT BE DOUBLED UP OR STACKED. BACK TO BACK CONNECTIONS ON OPPOSITE SIDES OF THE GROUND BUS ARE PERMITTED.
- 12. USE OF 90' BENDS IN THE PROTECTION GROUNDING CONDUCTORS SHALL BE AVOIDED WHEN 45' BENDS CAN BE ADEQUATELY
- 13. MAXIMUM RESISTANCE OF THE COMPLETED GROUND SYSTEM SHALL NOT EXCEED 5 OHMS. TESTING SHALL BE PERFORMED IN ACCORDANCE WITH PROJECT SPECIFICATIONS FOR FACILITY GROUNDING, USING FALL OF POTENTIAL METHOD.

STANDARD CONDUIT NOTES:

- 1. UNDERGROUND CONDUIT SHALL BE SCHEDULE 40 PVC. ABOVE GROUND CONDUIT, ELBOWS, AND RISERS SHALL BE SCHEDULE 80 PVC.
- 2. UNDERGROUND SERVICE CONDUIT SHALL MEET REQUIRED BURIAL DEPTH PER AMEREN ELECTRIC SERVICE MANUAL.
- 3. G.C. TO STUB UP SERVICE CONDUIT AT UTILITY POLE WITH 90' SWEEPING ELBOW. GC. SHALL COIL SUFFICIENT CONDUCTOR TO REACH SERVICE CONNECTION ON POLE. G.C. SHALL SUPPLY ENOUGH CONDUIT AND RISER HARDWARE FOR AMEREN TO EXTEND SERVICE RISER UP POLE TO SERVICE CONNECTION POINT. REFER TO AMEREN ELECTRIC SERVICE MANUAL FOR REQUIREMENTS.
- 4. ALL CONDUIT WILL BE EQUIPPED WITH 3/8" PULL ROPE AND HAVE A TRACER WIRE. TRACER WIRE NEEDS TO BE LAID ABOVE BURIED CONDUIT.







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ELECTRICAL SEAL

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SHEET TITLE

ELECTRICAL ONE-LINE DIAGRAM


SHEET NUMBER

E1

ELECTRICAL NOTES

SCALE N.T.S.

3

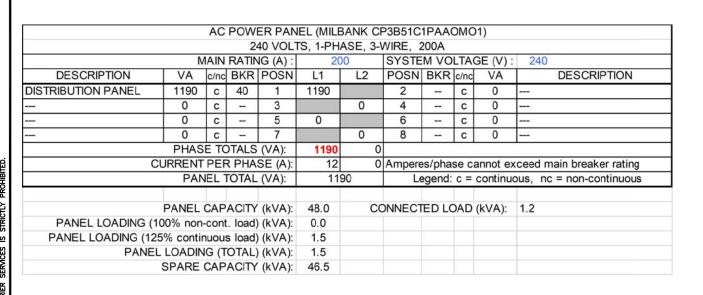

MANUFACTURER: MODEL: MILBANK CP3B51C1PAAOMO1


ELECTRICAL SPECIFICATIONS:
AMPERAGE RATING:
OPERATING VOLTAGE:
ELECTRICAL PHASE:
MAIN BREAKER SIZE:
GTY OF BRANCH CIRCUITS:
LINE SIDE WIRE RANGE: 200 A 240 V 1 PH 200 A 20 6 AWG — 350 kcmil

ENVIRONMENT SPECIFICATIONS: UL LISTED: NEMA RATING:

ADDITIONAL SPECIFICATIONS:
ON AMEREN ENERGY APPROVED LIST (SECTION 1100 OF ELECTRIC SERVICE MANUAL, DATED JANUARY 18, 2018)



"A" Style 16" Metered Commercial Pedestal

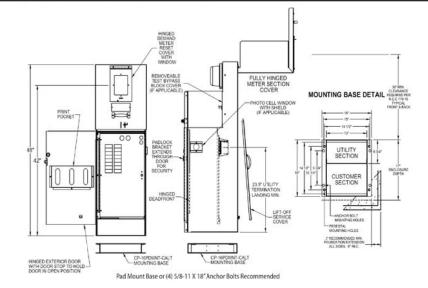

SPECIAL NOTE:
METER PEDESTAL SHALL BE PAINTED TO MATCH AT&T EQUIPMENT IN
RIGHT OF WAY. CONTRACTOR SHALL COORDINATE W/AT&T FOR COLOR
AND PROVIDE DOCUMENTATION OF SUCH TO CITY OF URBANA FOR

ELECTRICAL MAIN & LOAD CENTER PANEL SCHEDULE

SCALE N.T.S.

SCALE

N.T.S.

AC METER SOCKET W/MAIN & LOAD CENTER DETAIL

SCALE N.T.S.

2

PTS PTS90120 MECHANICAL SPECIFICATIONS: HEIGHT: WIDTH: DEPTH: WEIGHT: 10.13 IN 06.15 IN 06.00 IN 10 LBS ELECTRICAL SPECIFICATIONS: AMPERAGE: OPERATING VOLTAGE: QTY OF PROTECTED CIRCUITS:

ENVIRONMENT SPECIFICATIONS: NORMAL OPERATING TEMP.:

MANUFACTURER: MODEL:

-40°C TO +60°C









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SHEET TITLE

IPANEL SCHEDULE & ELECTRICAL **DETAILS**

SHEET NUMBER


E2

		AC	POW	ER PAN	IEL (RAY	CAP RS	CAC-65	33-P-1	20-D))	
			-	20 VOL	TS, 1-PH	ASE, 2-1	NIRE, 4	40A		72	
	N	MAIN	RATIN	IG (A):	4	0	SYSTE	M VO	TAC	E (V):	120
DESCRIPTION	VA	c/nc	BKR	POSN	L1	L2	POSN	BKR	c/nc	VA	DESCRIPTION
AWS RRUS-32 B66	704	С	7	1	704		2	7	С	0	SPARE
PCS RRUS-32 B2	704	С	7	3		704	4	7	С	0	SPARE
SPARE	0		7	5	0						
22	PHAS	SE TO	OTALS	(VA):	704	704	5		0		
C	7	7	Amperes/phase cannot exceed main breaker rating								
PANEL TOTAL (VA):						08	B Legend: c = continuous, nc = non-continuous				
	PANEL	CAF	ACITY	(kVA):	4.8	C	ONNECT	TED LO	DAD	(kVA):	1.4
PANEL LOADING (100% non-cont. load) (kVA):					0.0						
PANEL LOADING (125% continuous load) (kVA):					1.8						
PANEL LOADING (TOTAL) (kVA):					1.8						
	SPARE	CAF	ACITY	(kVA):	3.0						

AC DISTRIBUTION PANEL DETAIL

ELECTRICAL PANEL SCHEDULE

SCALE N.T.S.

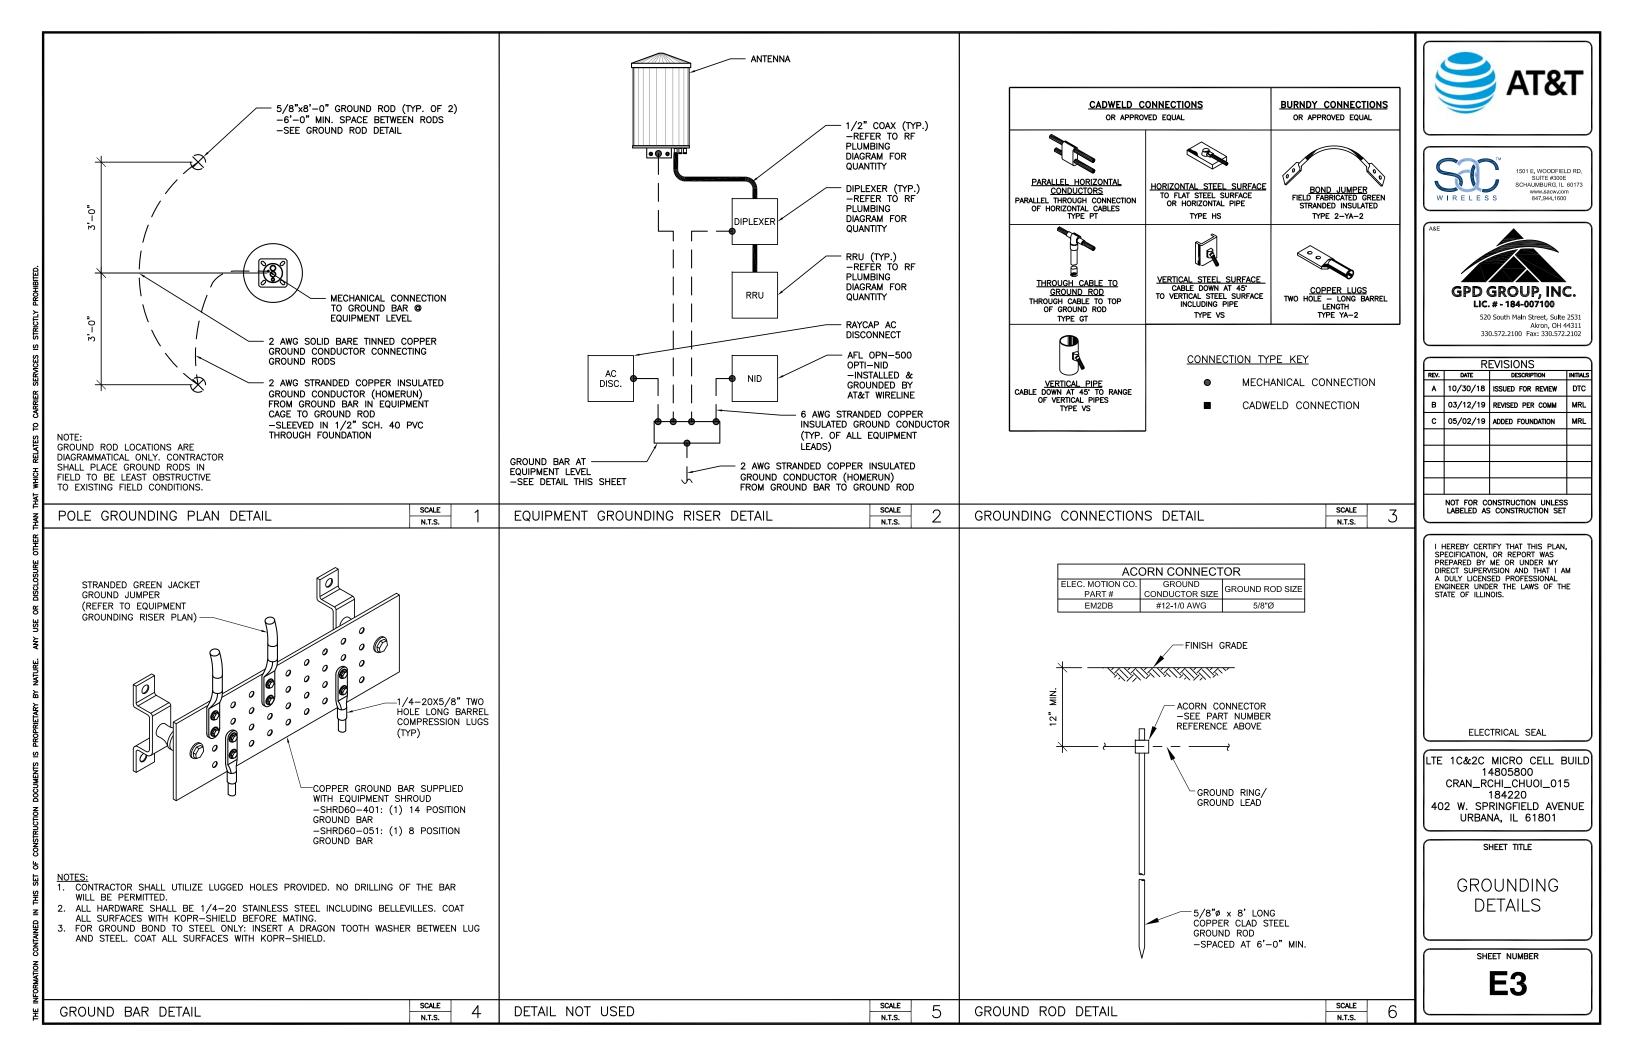


Configuration Name	700 MHz 2T2R LTE							THE RESERVE OF THE PARTY OF THE		3.5 GHz LAA LTE	1	The second state of the second	The second secon
Micro #17	Х	NA	NA	NA	NA	Х	NA	NA	NA	NA	1	2	14 Ports Antenna





Important Note:

For detailed radio to antenna wiring refer to the latest 4T4R Antenna/Radio Port Connection Field Notice (RF-HW-2016-234) and the 4T Wiring Playbook

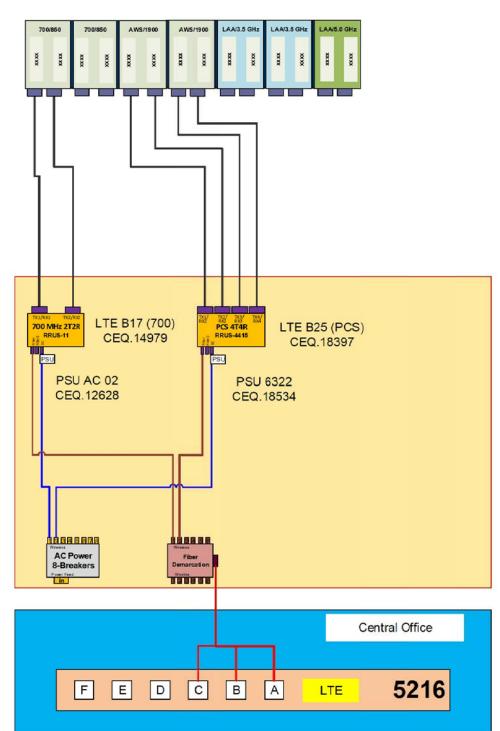





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REVISIONS							
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A	10/30/18	ISSUED FOR REVIEW	DTC				
В	03/12/19	REVISED PER COMM	MRL				
С	05/02/19	ADDED FOUNDATION	MRL				
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REFERENCE ONLY

LTE 1C&2C MICRO CELL BUILD 14805800 CRAN_RCHI_CHUOI_015 184220 402 W. SPRINGFIELD AVENUE URBANA, IL 61801

SHEET TITLE


RF PLUMBING DIAGRAM

SHEET NUMBER

RF1

RF PLUMBING DIAGRAM

SCALE N.T.S. **-**|| •

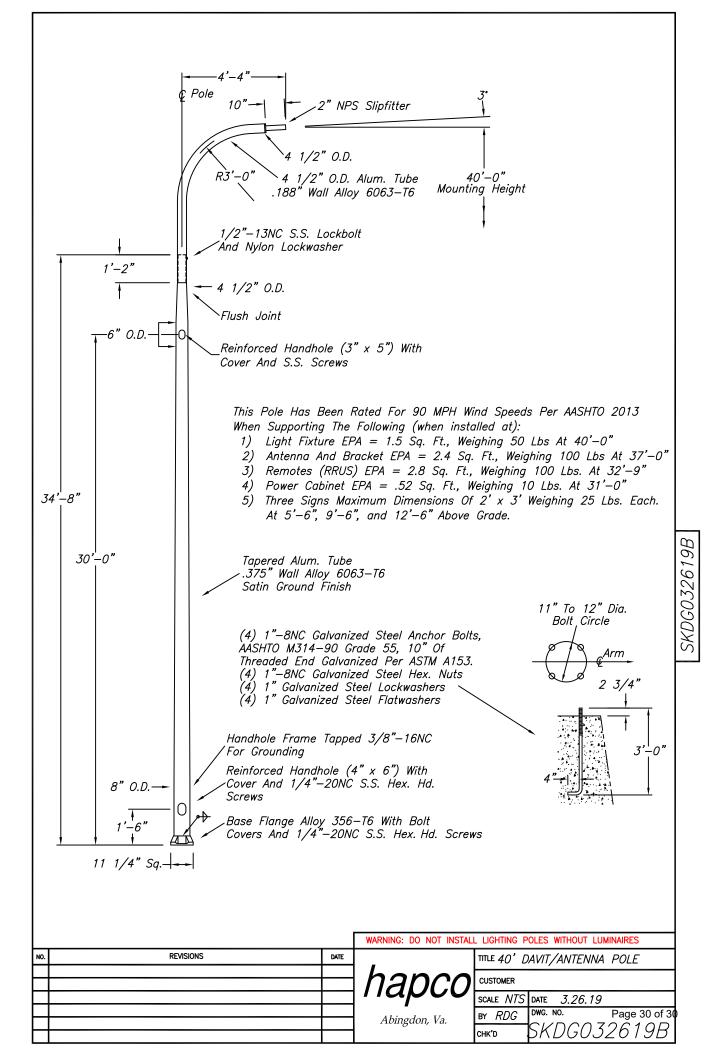

SITE NAME: COUNTY: ADDRESS:

CRAN_RCHI_CHUOI_009 CHAMPAIGN 544 S GOODWIN AVE URBANA, IL 61801 CITY OF URBANA

FA NUMBER:

14805794 3304A0AAPG / 3304A0AAPW

MRCHI025422 / MRCHI025403

LATITUDE: LONGITUDE: **ELEVATION:**

40° 06' 31.67" (40.108764°) 88° 13' 26.65" (-88.223793°)

LIGHT POLE/UTILITY POLE OWNÉR:

CITY OF URBANA

APPLICANT:

AT&T MOBILITY 930 NATIONAL PARKWAY SCHAUMBURG IL 60173

AT&T_PROJECT

MANAGER/SITE ACQUISITION:

VANESSA ROSS (217) 814-2314 VF2021@ATT.COM

AT&T CONSTRUCTION

MANAGER:

CHRISTIANA RACHAL CR630A@ATT.COM

PROJECT CONSULTANTS

PROJECT MANAGER: SAC WIRFLESS LLC

540 W. MADISON ST. (9TH FLOOR) CHICAGO IL 60661 CONTACT: PRITI MORE PHONE: (312) 789-4353 EMAIL: PRITI.MORE@SACW.COM

ARCHITECT:

GPD GROUP, INC. — 184—007100 520 S. MAIN ST., SUITE 2531 AKRON, OH 44311

JAMES HOM

SAC C.M. MARK KLEPACKI

EMAIL: MARK.KLEPACKI@SACW.COM

SAC P.M.

EMAIL: JAMES.HOM@SACW.COM

AT&T MOBILITY

PROJECT: LTE 1C&2C PICO CELL BUILD

SITE #: CRAN_RCHI_CHUOI_009

USID / NODE: 184214 FA #: 14805794


PTN #: 3304A0AAPG / 3304A0AAPW PACE #: MRCHI025422 / MRCH025403

ENODE B: ILL07042F R2

JURISDICTION: CITY OF URBANA

CRAN_RCHI_CHUOI_009 SITE NAME: 544 S GOODWIN AVE **ADDRESS:**

URBANA, IL 61801

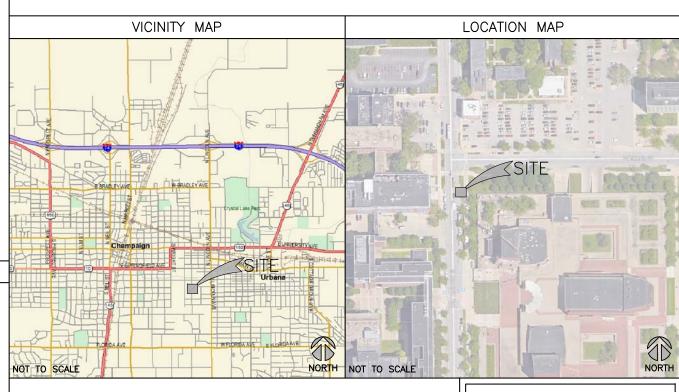



Know what's below. now what's below.

Call before you dig.

REQUIRES MIN OF 2
WORKING DAYS NOTICE
BEFORE YOU EXCAVATION

	51, 11110
T1	TITLE SHEET
A1	FIBER DELIVERY PLANS (REFERENCE ONLY)
A2	OVERALL SITE PLAN
A3	ENLARGED PLAN
A4	EXISTING LIGHT POLE ELEVATION
A5	PROPOSED LIGHT POLE ELEVATIONS
A6	EQUIPMENT SHROUD DETAILS (REFERENCE ONLY)
A7	EQUIPMENT DETAILS (REFERENCE ONLY)
A8	MOUNTING DETAILS
S1	POLE FOUNDATION DETAILS
E1	ELECTRICAL ONE—LINE DIAGRAM
E2	PANEL SCHEDULE & ELECTRICAL DETAILS
E3	GROUNDING DETAILS
RF1	RF PLUMBING DIAGRAM (REFERENCE ONLY)
REF	POLE MANUFACTURER DESIGN (BY OTHERS)
	SCOPE OF WORK

DRAWING INDEX

THIS IS NOT AN ALL INCLUSIVE LIST. CONTRACTOR SHALL UTILIZE SPECIFIED EQUIPMENT PART OR ENGINEER APPROVED EQUIVALENT. CONTRACTOR SHALL VERIFY ALL NEEDED EQUIPMENT TO PROVIDE A FUNCTIONAL SITE. THE PROJECT GENERALLY CONSISTS OF THE FOLLOWING:

- REMOVE EXISTING LIGHT POLE AND REPLACE WITH NEW 30' HAPCO DAVIT
- ARM (RTA30D8B4D1A) LIGHT POLE (BLACK POWDER COAT 5 YR)

 INSTALL NEW ELECTRIC SERVICE RUN FROM EXISTING SOURCE TO NEW LIGHT POLE. METER SUPPLIED & INSTALLED BY CONTRACTOR.

 INSTALL NEW FIBER SERVICE RUN FROM EXISTING SOURCE TO NEW LIGHT
- POLE LOCATION AS SHOWN.
- INSTALL NEW POWER & FIBER EQUIPMENT PER PLAN
- INSTALL (1) NEW OMNI ANTENNA
- INSTALL (2) PCS 2203 RRUS & (1) LAA 2205 RRU IN CHARLES DENSIFICATION SHROUD
- INSTALL CABLING AS REQUIRED
- GROUND AS REQUIRED
- LIGHT POLE LUMINARY TO BE SUPPLIED & INSTALLED BY CONTRACTOR. LUMINARY MUST BE APPROVED BY CITY OF URBANA PRIOR TO ORDER. STREET LIGHTING HANDHOLE (IF REQUIRED) SUPPLIED & INSTALLED BY
- POTHOLING SHALL BE REQUIRED FOR ANY PROPOSED UTILITY CROSSING
- HYDROVAC SHALL BE USED FOR ALL TRENCHING & POTHOLING ACTIVITIES CONTRACTOR SHALL MAINTAIN INTEGRITY OF EXISTING POLE DURING REMOVAL & COORDINATE RETURN OF REMOVED POLE TO THE CITY OF URBANA

UTILITY DELIVERY METHOD TO PROPOSED POLE - FIBER - UNDERGROUND

- POWER - UNDERGROUND

CODE COMPLIANCE

- 2015 INTERNATIONAL BUILDING CODE W/CITY AMMENDMENTS
- 2014 NATIONAL ELECTRIC CODE W/CITY AMMENDMENTS

SPECIAL NOTES

- ALL WORK SHALL BE INSTALLED IN CONFORMANCE WITH CURRENT AT&T CONSTRUCTION INSTALLATION GUIDE.
- EXISTING CONDITIONS WILL BE CHANGED & VERIFIED IN FIELD. IF SIGNIFICANT DEVIATIONS OR DETERIORATION ARE ENCOUNTERED AT THE TIME OF CONSTRUCTION, A REPAIR PERMIT WILL BE OBTAINED & CONTRACTOR SHALL NOTIFY ENGINEER IMMEDIATELY.
- THESE DRAWINGS ARE FULL SIZE & SCALEABLE ON 11"X17" SHEET SIZE. STATEMENT THAT COMPLIANCE WITH THE ENERGY CODE IS NOT REQUIRED. -SCOPE OF WORK DOES NOT INVOLVE MODIFICATIONS TO EXTERIOR ENVELOPE OF BUILDING, HVAC SYSTEMS OR ELECTRICAL LIGHTING

DO NOT SCALE DRAWINGS

CONTRACTOR SHALL VERIFY ALL PLANS & EXISTING DIMENSIONS & CONDITIONS ON THE JOB SITE & SHALL IMMEDIATELY NOTIFY THE ARCHITECT OR ENGINEER IN WRITING OF ANY DISCREPANCIES BEFORE PROCEEDING WITH THE WORK OR BE RESPONSIBLE FOR SAME.





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С	05/02/19	ADDED FOUNDATION	MRL		
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CIVIL SEAL


LTE 1C&2C PICO CELL BUILD 14805794 CRAN_RCHI_CHUOI_009 184214 544 S GOODWIN AVE URBANA, IL 61801


SHEET TITLE

TITLE SHEET

SHEET NUMBER

SAC File: T:\ATandT\184214\01 2017732 65 SAC\AE\CD\CRAN_RCHI_CHUOI_009 CD.dwg 05/02/19 11:37

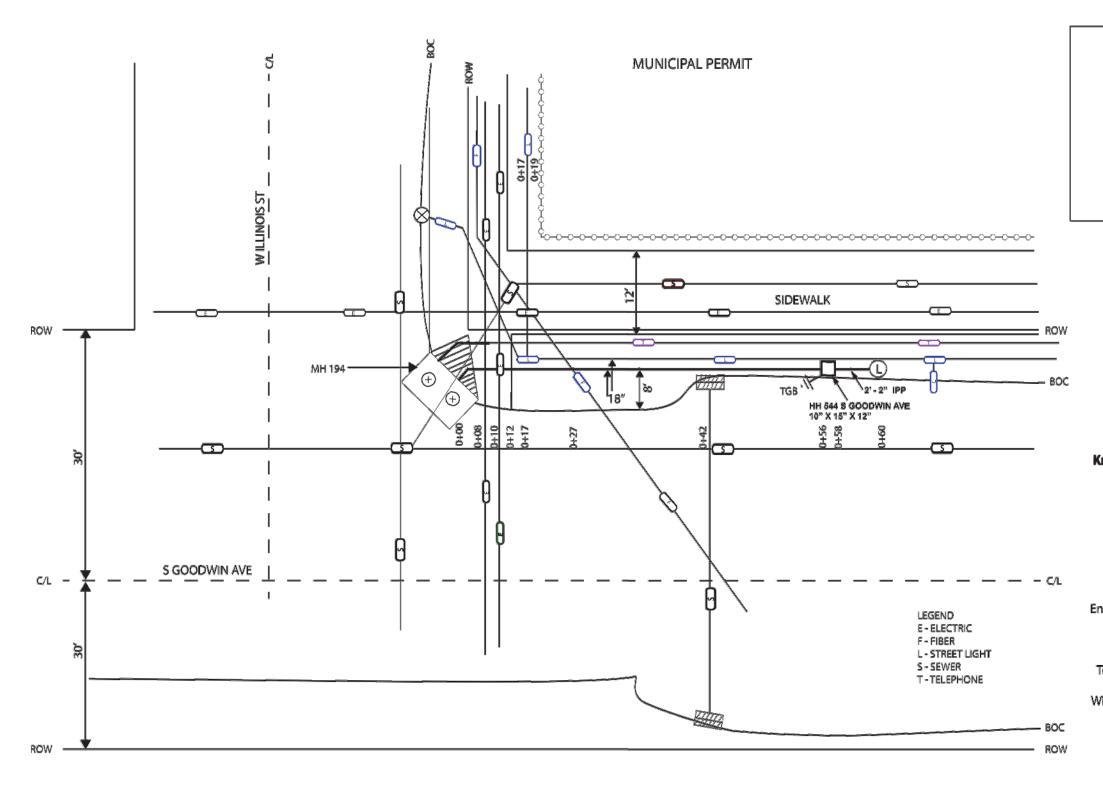

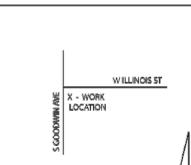



201 S NEIL St, FLR 1 Champaign, IL 61820

Job# A01BZJ2
Engineer: Michael Murphy
Tel No: 217-398-7979
Quarter: 18 NE
Municipality: Urbana
Township: Cunningham
County: Champaign
Wire Center: Cunningham
Sheet 1 of 1







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REFERENCE ONLY

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14805794
CRAN_RCHI_CHUOI_009
184214
544 S GOODWIN AVE
URBANA, IL 61801

SHEET TITLE

FIBER DELIVERY PLANS


SHEET NUMBER

A1

SCALE N.T.S.

FIBER DELIVERY PLANS (PROVIDED BY AT&T)

-

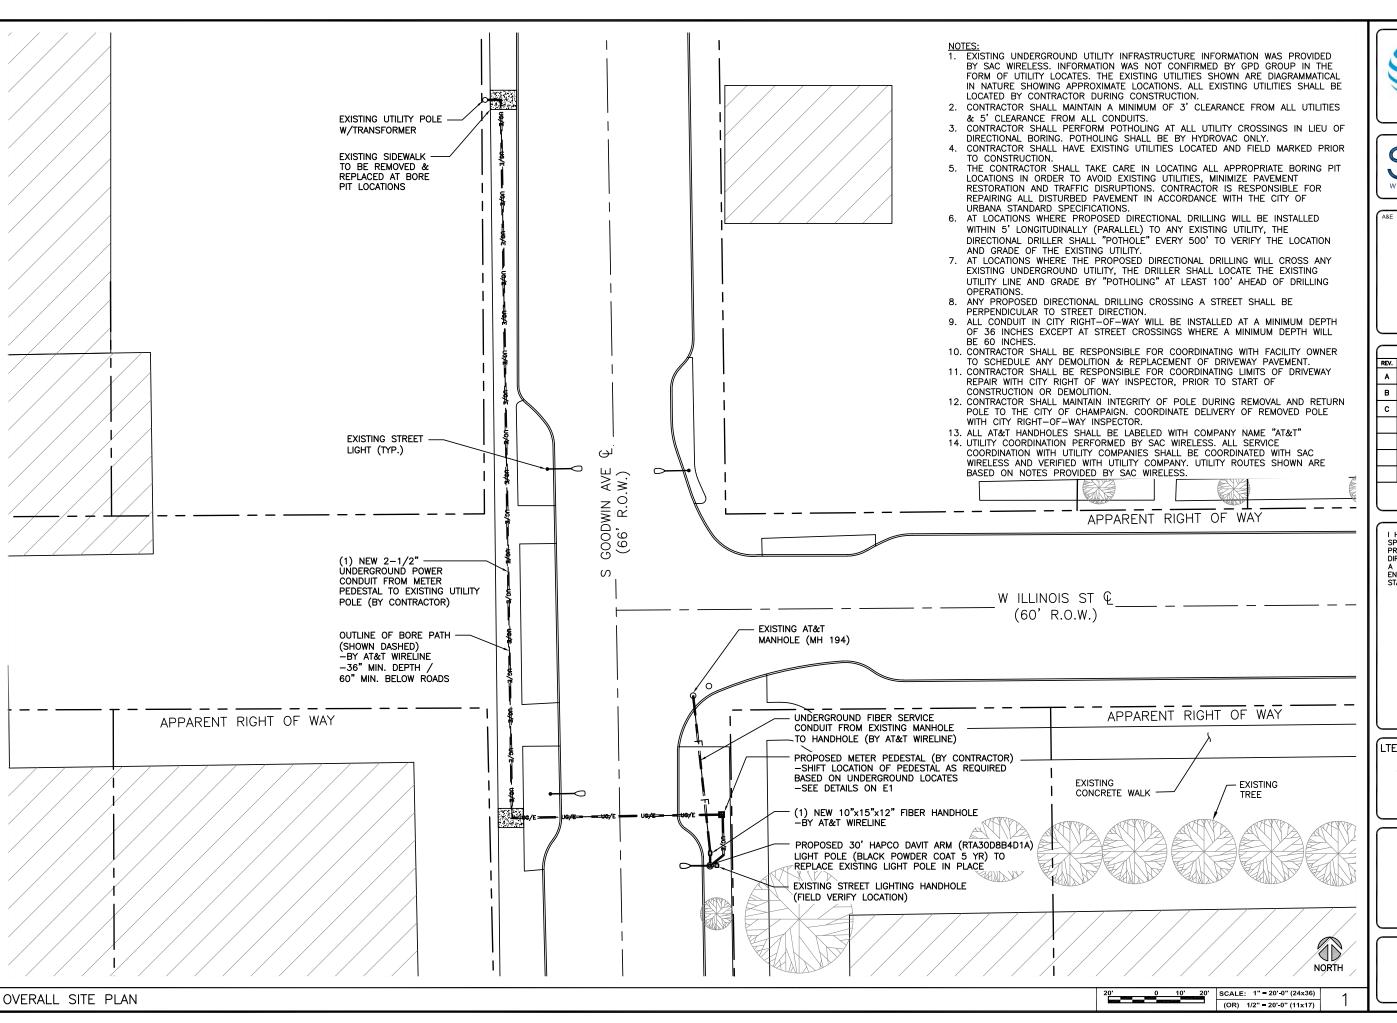







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CIVIL SEAL


LTE 1C&2C PICO CELL BUILD 14805794 CRAN_RCHI_CHUOI_009 184214 544 S GOODWIN AVE URBANA, IL 61801


SHEET TITLE

OVERALL SITE PLAN

SHEET NUMBER

A2

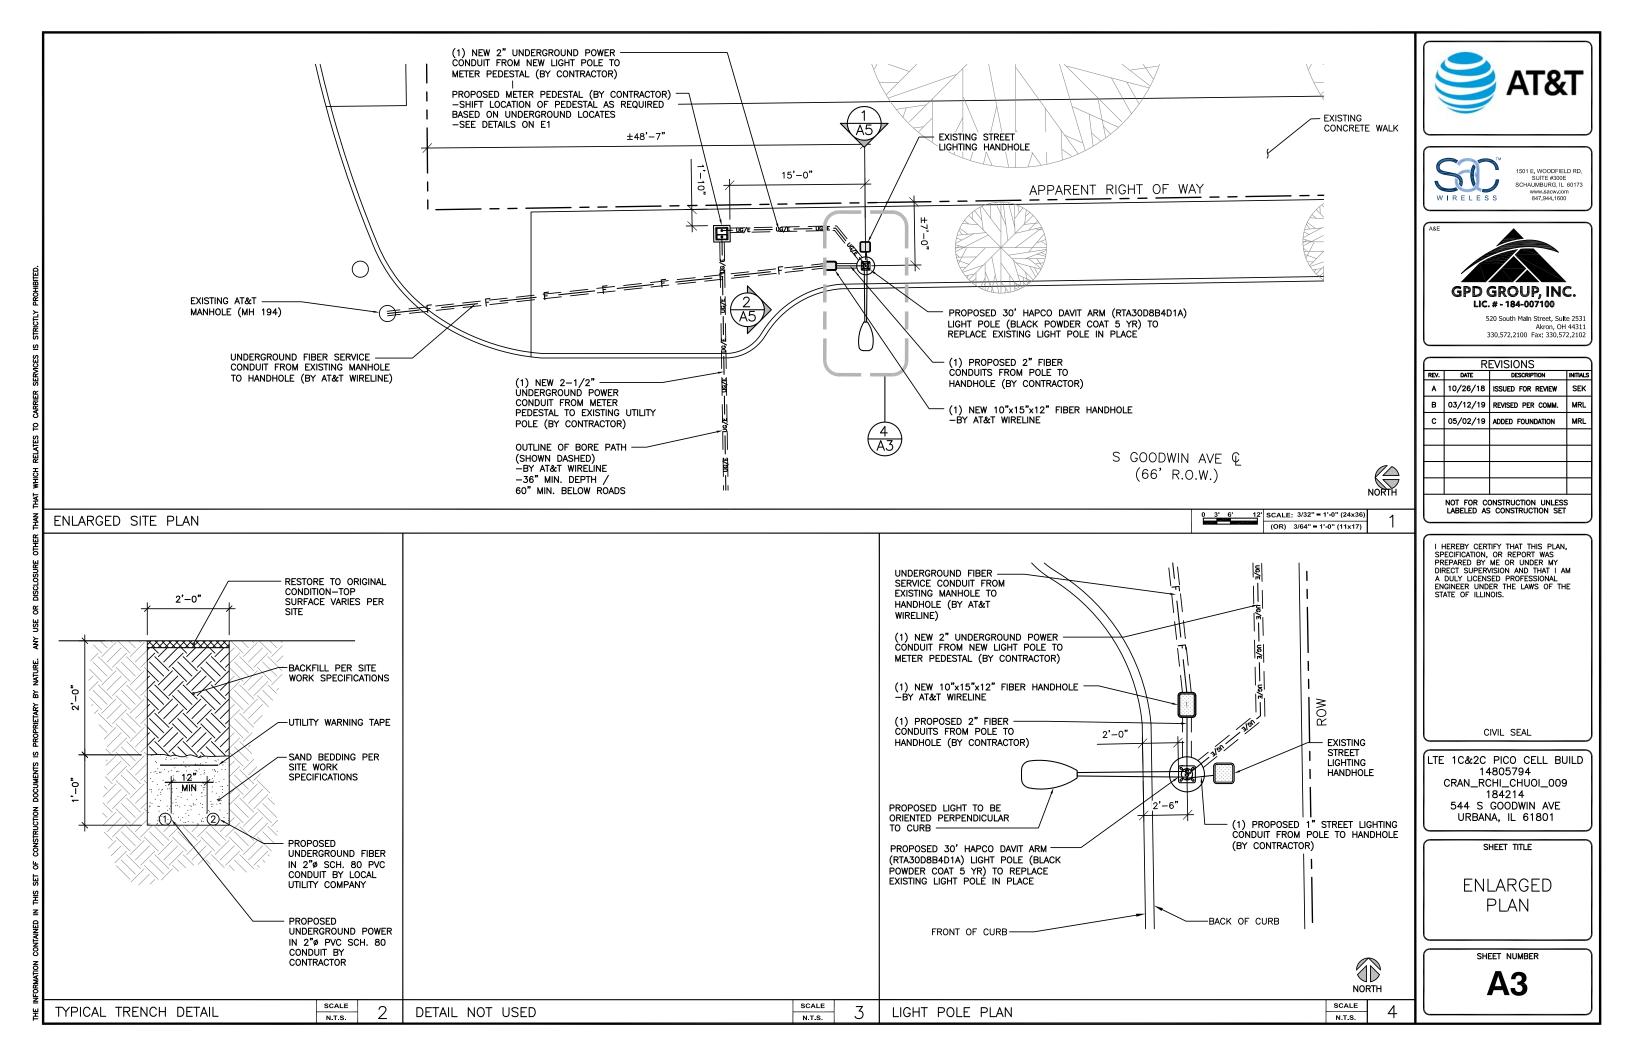

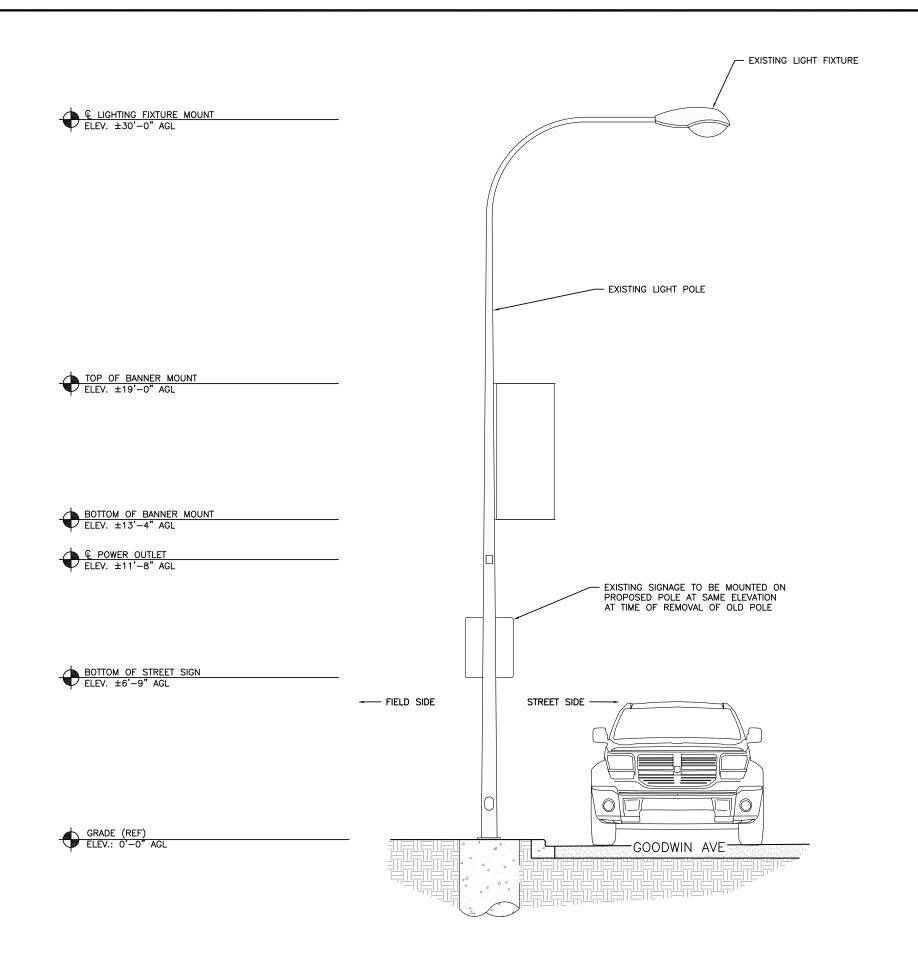







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\bigcap	REVISIONS			
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CIVIL SEAL

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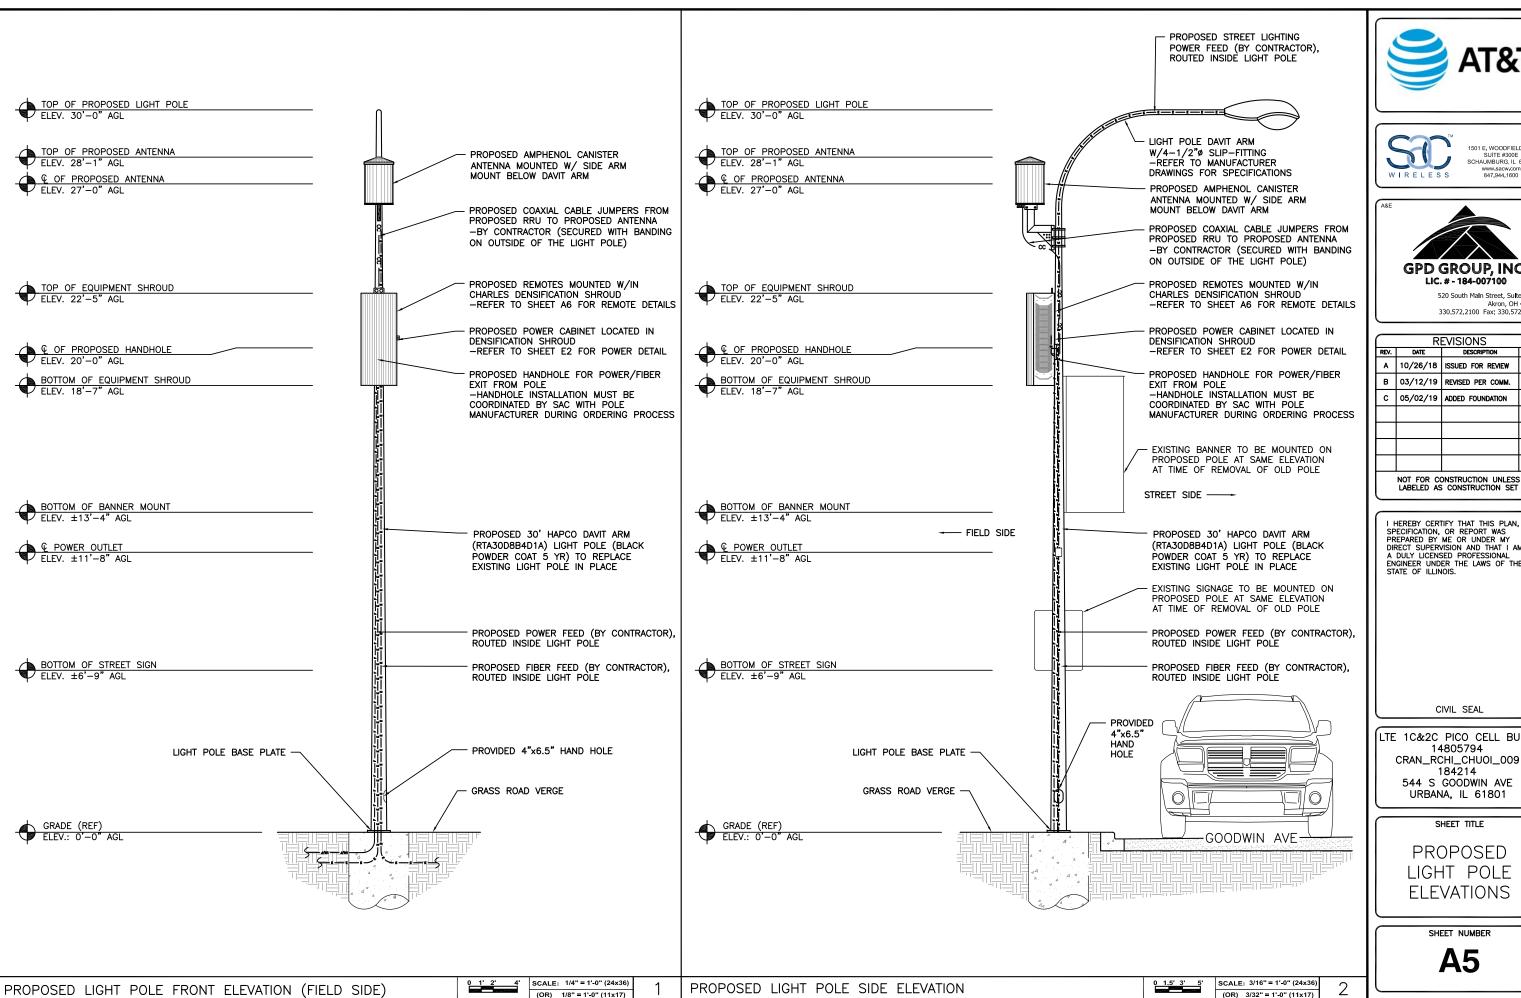
SHEET TITLE

EXISTING LIGHT POLE ELEVATION

SHEET NUMBER

A4

0 1' 2' 4' SCALE: 1/4" = 1'-0" (24x36)
(OR) 1/8" = 1'-0" (11x17)









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CIVIL SEAL


LTE 1C&2C PICO CELL BUILD 14805794 CRAN_RCHI_CHUOI_009 184214 544 S GOODWIN AVE URBANA, IL 61801

SHEET TITLE

PROPOSED LIGHT POLE **ELEVATIONS**

SHEET NUMBER

A5

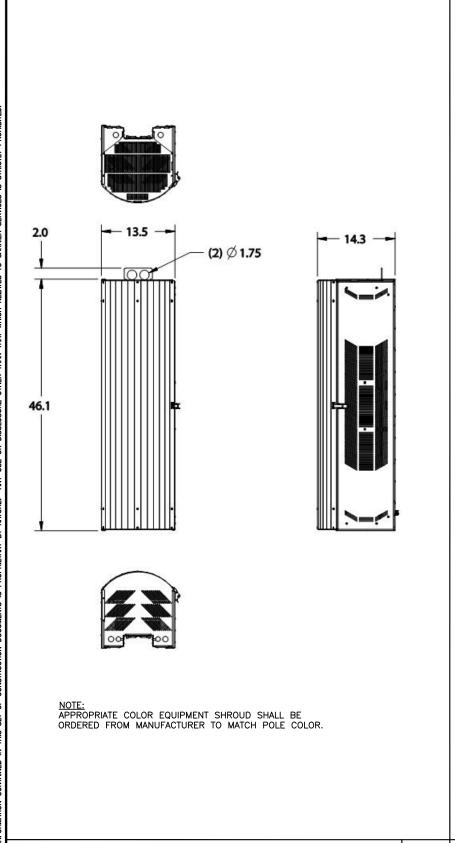







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\cap	R	EVISIONS	
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REFERENCE ONLY

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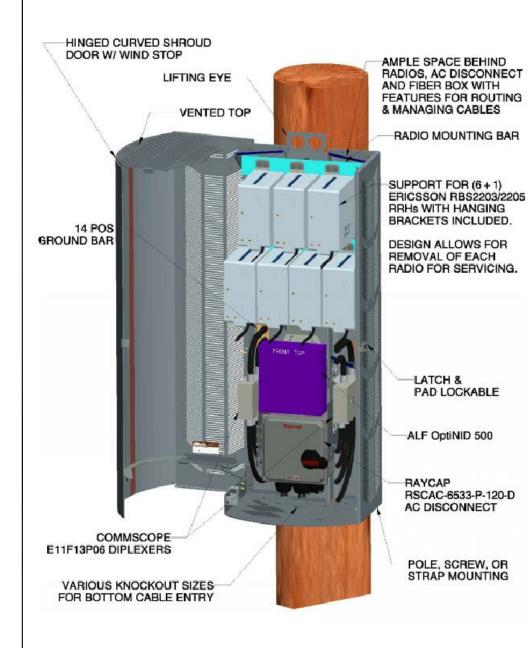
SHEET TITLE

EQUIPMENT SHROUD DETAILS


SHEET NUMBER

3

A6




46.1" TALL EQUIPMENT SHROUD DETAIL 1 DETAIL NOT USED 2 EQUIPMENT SHROUD LAYOUT SCALE: NTS

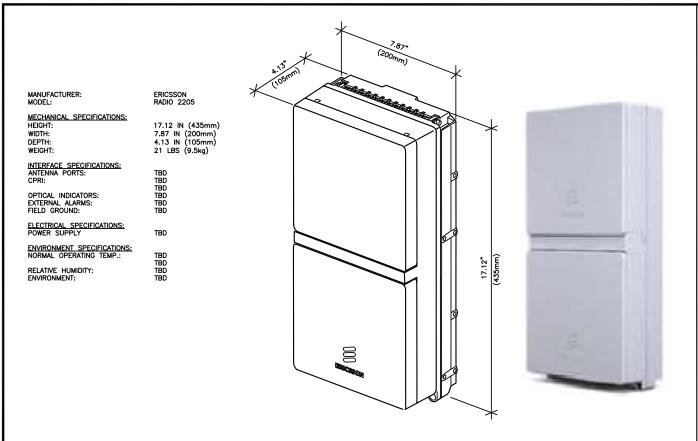

RRU 2205 DETAIL

DETAIL NOT USED

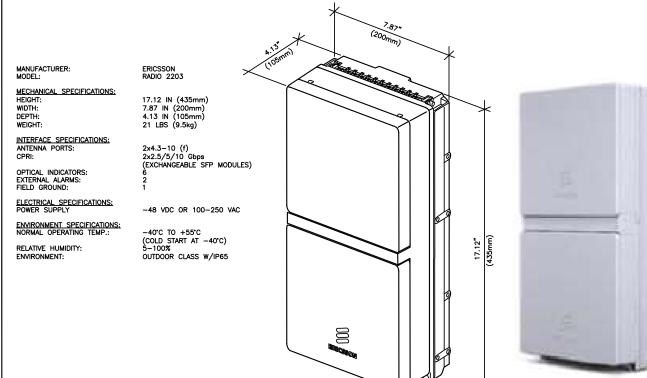





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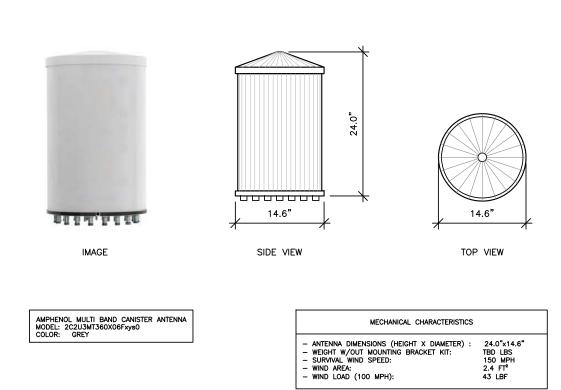
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SHEET TITLE

EQUIPMENT DETAILS

SHEET NUMBER

A7



RRU 2203 DETAIL

4

SCALE

N.T.S.


SCALE N.T.S.

ANTENNA DETAIL

SCALE

N.T.S.


SCALE: NTS

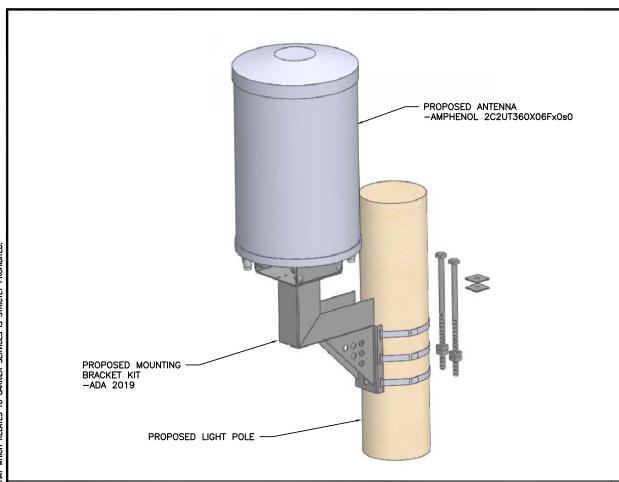

ANTENNA MOUNTING DETAIL

SCALE

N.T.S.

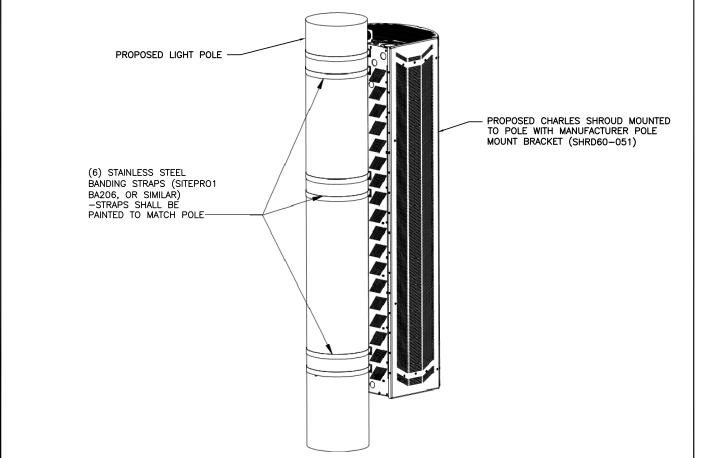

SHROUD MOUNTING DETAIL


EXAMPLE CRAN RF CAUTION SIGN

A CAUTION AT&T operates antennas at this structure. Above this point you are entering an area where radio frequency (RF) fields may exceed the FCC General Occupational Exposure limits. Follow safety guidelines for working in an RF environment. Keep 1 ft. away from the fronts of antennas. Contact AT&T at 800-638-2822, opt. 9, 3 and follow their instructions prior to performing any maintenance or repairs

Cell Site USID.

above this point.

EXAMPLE CRAN RF NOTICE SIGN

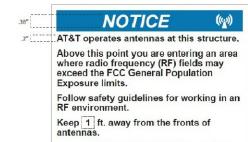


Contact AT&T at 800-638-2822, opt. 9, 3 and follow their instructions prior to performing any maintenance or repairs above this point.

This is AT&T Site USID_

EXAMPLE CRAN POLE POWER DISCONNECT SIGN



EXAMPLE STONEHOUSE RD899 RF NOTICE SIGN

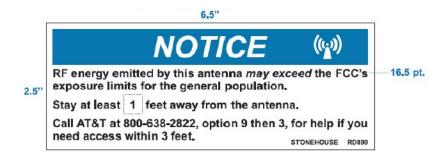

CRAN Pole Power Disconnect, RF Notice, and Caution signs shall be ordered through Stonehouse Signs. Three versions are available for each of the signs shown in Figures 16, 17, and 18: .055 Polyethylene – Reflective, .025 Aluminum – Reflective, and Peel Back Label – Reflective. All versions are 6°x6" with font designed to be visible from 2-3 feet away when approached from below to provide warning about ascending into the high RF exposure areas. The RF Caution sign shown in Figure 19 is designed to be visible from 3 feet away and is available in the reflective peel back label version only. It is designed to fit on most of the CRAN/Small Cell antenna types currently deployed. It may also be placed on antenna shrouds as shown in Figures 11 and 12.

SIGNAGE NOTE:
SIGNAGE SHALL BE INSTALLED PER AT&T DIRECTION

SAT&T



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REFERENCE ONLY

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SHEET TITLE

MOUNTING DETAILS

SHEET NUMBER

A8

AT&T SIGNAGE DETAIL


SCALE

N.T.S.

T SIGNACE DETAIL

SCALE: NTS

3

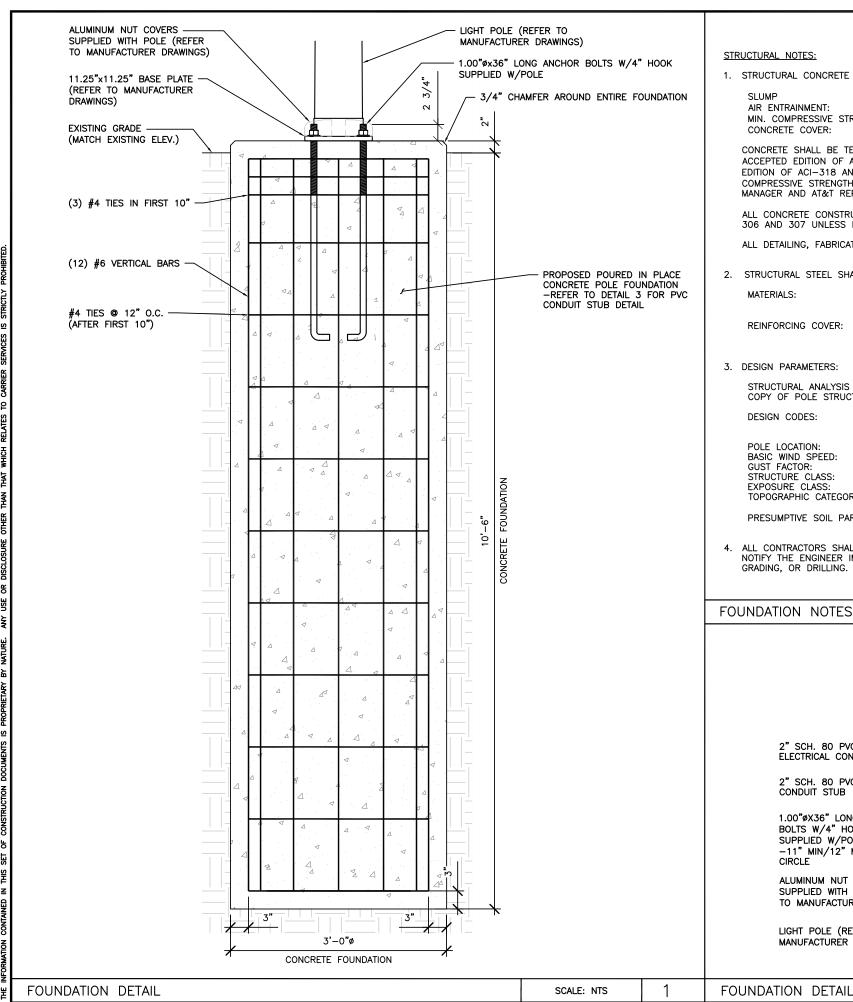

STRUCTURAL NOTES:

1. STRUCTURAL CONCRETE SHALL MEET THE FOLLOWING SPECIFICATIONS:

 $4" (\pm 1")$ AIR ENTRAINMENT: 6% (±1%) MIN. COMPRESSIVE STRENGTH (F'c): 4,500 PSI @ 28 DAYS CONCRETE COVER: 3" ALL SIDES

CONCRETE SHALL BE TESTED BY A REPUTABLE INDEPENDENT THIRD PARTY TESTING AGENCY IN ACCORDANCE WITH LATEST WISCONSIN ACCEPTED EDITION OF ACI-318. FIVE (5) CONCRETE CYLINDERS SHALL BE CAST IN ACCORDANCE WITH LATEST WISCONSIN ACCEPTED EDITION OF ACI-318 AND BE LABORATORY CURED. THE AVERAGE OF THREE (3) CONCRETE CYLINDERS SHALL HAVE A MINIMUM COMPRESSIVE STRENGTH (F'c) OF 4,500 PSI AT 28 DAYS. THE TESTING RESULTS SHALL BE PROVIDED TO THE CONSTRUCTION MANAGER AND AT&T REPRESENTATIVE.

ALL CONCRETE CONSTRUCTION SHALL CONFORM TO ACI*96, "STANDARD SPECIFICATION FOR STRUCTURAL CONCRETE" AND ACI 305, 306 AND 307 UNLESS NOTED OTHERWISE.

ALL DETAILING, FABRICATION AND PLACING OF CONCRETE SHALL CONFORM TO ACI 318-11.

2. STRUCTURAL STEEL SHALL MEET THE FOLLOWING SPECIFICATIONS:

REINFORCING ASTM 615, GRADE 60 MATERIALS: ANCHOR BOLTS ASTM F1554, GRADE 55

REINFORCING COVER: TOP воттом 3"

3. DESIGN PARAMETERS:

STRUCTURAL ANALYSIS OF THE POLE AND FOUNDATION WAS COMPLETED BY OTHERS. COORDINATE WITH SAC WIRELESS FOR A COPY OF POLE STRUCTURAL ANALYSIS.

DESIGN CODES: 2015 INTERNATIONAL BUILDING BUILDING CODE

TIA-222-G

POLE LOCATION: CHAMPAIGN COUNTY, IL

BASIC WIND SPEED: GUST FACTOR: 130 MPH 1.14 STRUCTURE CLASS: CLASS II

EXPOSURE CLASS: TOPOGRAPHIC CATEGORY:

MANUFACTURER DRAWINGS)

PRESUMPTIVE SOIL PARAMETERS: FOUNDATION IS BASED ON AN ALLOWABLE LATERAL BEARING PRESSURE OF AT LEAST 200 PSF/FT.

4. ALL CONTRACTORS SHALL EXERCISE GREAT CARE DURING EXCAVATION. CONTRACTOR SHALL PREDETERMINE UTILITY LOCATIONS AND NOTIFY THE ENGINEER IMMEDIATELY IF DEVIATION FROM PLANS EXIST. CONTRACTOR SHALL CONTACT 811 48 HR. PRIOR TO DIGGING, GRADING, OR DRILLING.

FOUNDATION NOTES

3'-0"ø REINFORCED CONCRETE FOUNDATION 2" SCH. 80 PVC LIGHTING 2" SCH. 80 PVC FIBER ELECTRICAL CONDUIT STUB CONDUIT STUB 2" SCH. 80 PVC ELECTRIC CONDUIT STUB 1.00"øX36" LONG ANCHOR BOLTS W/4" HOOK 1/2" SCH. 80 PVC SUPPLIED W/POLE GROUNDING CONDUIT STUB -11" MIN/12" MAX BOLT CIRCLE ALUMINUM NUT COVERS -SUPPLIED WITH POLE (REFER 11.25"X11.25" BASE PLATE TO MANUFACTURER DRAWINGS) (REFER TO MANUFACTURER DRAWINGS) LIGHT POLE (REFER TO





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SCALE

N.T.S.

2

3

SCALE: NTS

STRUCTURAL SEAL


LTE 1C&2C PICO CELL BUILD 14805794 CRAN_RCHI_CHUOI_009 184214 544 S GOODWIN AVE URBANA, IL 61801


SHEET TITLE

POLE **FOUNDATION** DETAILS

SHEET NUMBER

S1

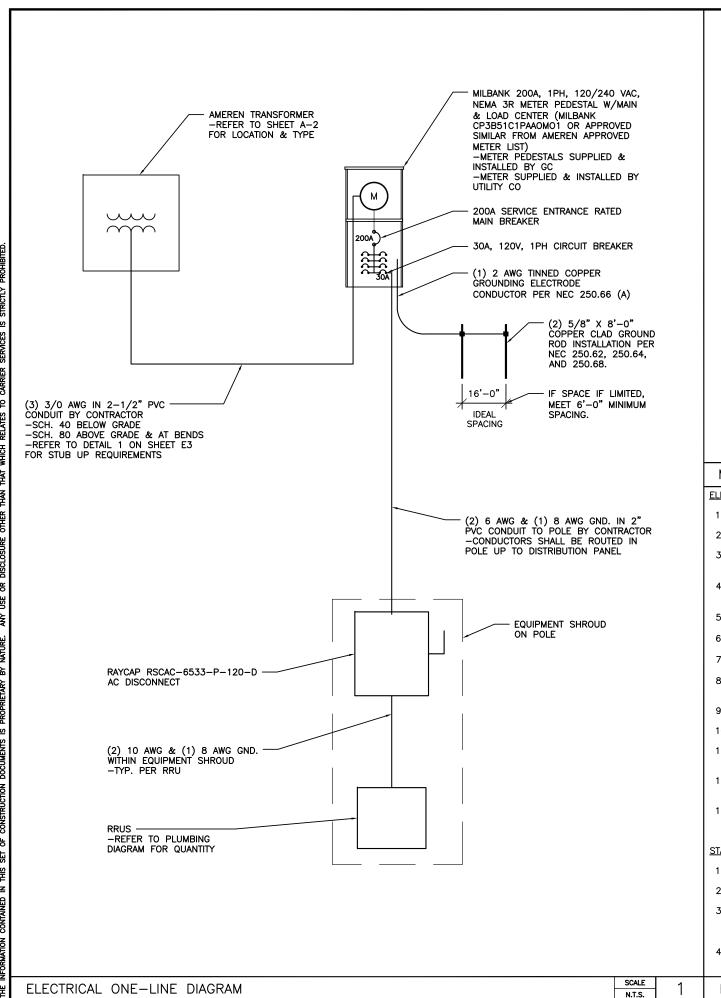

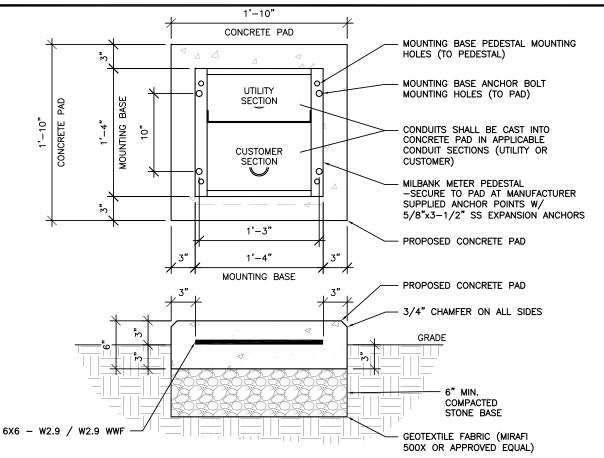

METER PEDESTAL CONCRETE PAD FOUNDATION DETAIL

SCALE N.T.S.

2

ELECTRICAL NOTES:

- 1. ALL ELECTRICAL WORK SHALL BE IN ACCORDANCE WITH THE PROJECT SPECIFICATIONS AND ALL APPLICABLE CODES.
- 2. CONDUIT ROUTINGS ARE SCHEMATIC. SUBCONTRACTOR SHALL INSTALL CONDUITS SUCH THAT ACCESS TO EQUIPMENT IS NOT BLOCKED.
- 3. SUBCONTRACTOR IS RESPONSIBLE FOR PROPERLY SEQUENCING THE INSTALLATION OF GROUNDING AND UNDERGROUND CONDUIT AS TO PREVENT THE LOSS OF CONTINUITY IN THE GROUNDING SYSTEM OR DAMAGE TO THE CONDUIT.
- 4. COMPRESSION GROUND CONNECTIONS MAY BE REPLACED BY EXOTHERMIC (CADWELD) CONNECTIONS WHEN APPROVED BY CINCINNATI BELL CONSTRUCTION MANAGER.
- 5. SERVICE TO METER PEDESTAL SHALL BE 120/240VAC, 200 AMP, SINGLE PHASE.
- 6. ALL GROUND CONNECTIONS BELOW GRADE SHALL BE EXOTHERMIC (CADWELD).
- 7. ALL GROUND CONNECTIONS ABOVE GRADE SHALL BE FORMED USING TWO (2) HIGH PRESS CRIMPS.
- 8. ALL EXOTHERMIC CONNECTIONS TO THE GROUND RODS SHALL START AT THE TOP AND HAVE A VERTICAL SEPARATION OF 6" FOR EVERY ADDITIONAL CONNECTION.
- 9. ALL EXTERIOR GROUND CONNECTIONS SHALL BE COATED WITH A CORROSION RESISTANT MATERIAL.
- 10. ALL EXTERIOR GROUND CONNECTORS SHALL BE 2 AWG SOLID BARE, TINNED, COPPER UNLESS INDICATED OTHERWISE.
- 11. CONNECTIONS TO THE GROUND BUS SHALL NOT BE DOUBLED UP OR STACKED. BACK TO BACK CONNECTIONS ON OPPOSITE SIDES OF THE GROUND BUS ARE PERMITTED.
- 12. USE OF 90' BENDS IN THE PROTECTION GROUNDING CONDUCTORS SHALL BE AVOIDED WHEN 45' BENDS CAN BE ADEQUATELY
- 13. MAXIMUM RESISTANCE OF THE COMPLETED GROUND SYSTEM SHALL NOT EXCEED 5 OHMS. TESTING SHALL BE PERFORMED IN ACCORDANCE WITH PROJECT SPECIFICATIONS FOR FACILITY GROUNDING, USING FALL OF POTENTIAL METHOD.

STANDARD CONDUIT NOTES:

- 1. UNDERGROUND CONDUIT SHALL BE SCHEDULE 40 PVC. ABOVE GROUND CONDUIT, ELBOWS, AND RISERS SHALL BE SCHEDULE 80 PVC.
- 2. UNDERGROUND SERVICE CONDUIT SHALL MEET REQUIRED BURIAL DEPTH PER AMEREN ELECTRIC SERVICE MANUAL.
- 3. G.C. TO STUB UP SERVICE CONDUIT AT UTILITY POLE WITH 90' SWEEPING ELBOW. GC. SHALL COIL SUFFICIENT CONDUCTOR TO REACH SERVICE CONNECTION ON POLE. G.C. SHALL SUPPLY ENOUGH CONDUIT AND RISER HARDWARE FOR AMEREN TO EXTEND SERVICE RISER UP POLE TO SERVICE CONNECTION POINT. REFER TO AMEREN ELECTRIC SERVICE MANUAL FOR REQUIREMENTS.
- 4. ALL CONDUIT WILL BE EQUIPPED WITH 3/8" PULL ROPE AND HAVE A TRACER WIRE. TRACER WIRE NEEDS TO BE LAID ABOVE BURIED CONDUIT.







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С	05/02/19	ADDED FOUNDATION	MRL	
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SHEET TITLE

ELECTRICAL ONE-LINE DIAGRAM


SHEET NUMBER

E1

ELECTRICAL NOTES

SCALE N.T.S.

3

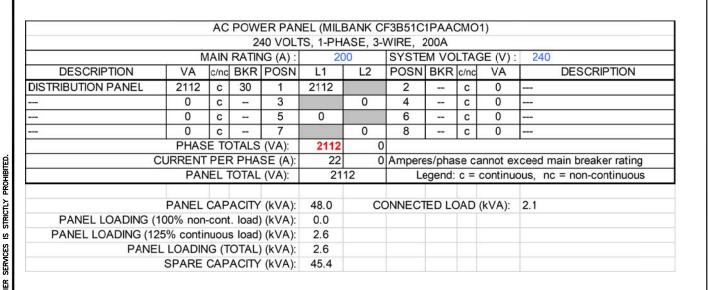

MANUFACTURER: MILBANK
MODEL: CP3B51C1PAAOMO1

MECHANICAL SPECIFICATIONS:
HEIGHT: 48 IN
WIDTH: 16 IN
DEPTH: 17 IN

ELECTRICAL SPECIFICATIONS:
AMPERAGE RATING: 200 A
OPERATING VOLTAGE: 240 V
ELECTRICAL PHASE: 1 PH
MAIN BREAKER SIZE: 200 A
OTY OF BRANCH CIPCLUTS: 200 A


MAIN BREAKER SIZE: 200 A
QTY OF BRANCH CIRCUITS: 20
LINE SIDE WIRE RANGE: 6 AWG - 350 kcmil

ENVIRONMENT SPECIFICATIONS:
UL LISTED: YES
NEMA RATING: 3R

ADDITIONAL SPECIFICATIONS:
ON AMEREN ENERGY APPROVED LIST (SECTION 1100 OF ELECTRIC SERVICE MANUAL, DATED JANUARY 18, 2018)



"A" Style 16" Metered Commercial Pedestal

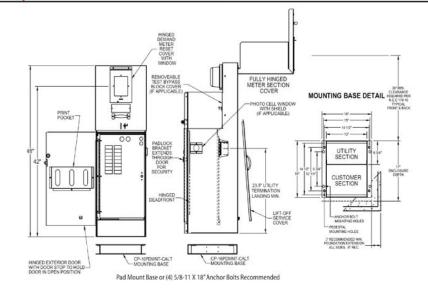

SPECIAL NOTE:
METER PEDESTAL SHALL BE PAINTED TO MATCH AT&T EQUIPMENT IN
RIGHT OF WAY. CONTRACTOR SHALL COORDINATE W/AT&T FOR COLOR
AND PROVIDE DOCUMENTATION OF SUCH TO CITY OF URBANA FOR
APPROVAL PRIOR TO CONSTRUCTION.

ELECTRICAL MAIN & LOAD CENTER PANEL SCHEDULE

scale n.t.s.

AC METER SOCKET W/MAIN & LOAD CENTER DETAIL

SCALE N.T.S.

2

AC POWER PANEL (RAYCAP RSCAC-6533-P-120-D) 120 VOLTS, 1-PHASE, 2-WIRE, 30A MAIN RATING (A): SYSTEM VOLTAGE (V): DESCRIPTION VA c/nc BKR POSN L1 L2 POSN BKR c/nc VA DESCRIPTION 704 c RRUS-2203 704 RRUS-2205 1408 7 2 7 c RRUS-2203 704 c 7 704 4 0 7 | c | PHASE TOTALS (VA): 1408 704 CURRENT PER PHASE (A): 15 7 Amperes/phase cannot exceed main breaker rating PANEL TOTAL (VA): 2112 Legend: c = continuous, nc = non-continuous PANEL CAPACITY (kVA): CONNECTED LOAD (kVA): 2.1 3.6 PANEL LOADING (100% non-cont. load) (kVA): PANEL LOADING (125% continuous load) (kVA): 2.6 PANEL LOADING (TOTAL) (kVA): 2.6 SPARE CAPACITY (kVA): 1.0

MANUFACTURER: MODEL:

MECHANICAL SPECIFICATIONS: HEIGHT: WIDTH:

WIDTH: DEPTH: WEIGHT:

ELECTRICAL SPECIFICATIONS:
AMPERAGE:
OPERATING VOLTAGE:
QTY OF PROTECTED CIRCUITS:
CONNECTION TERMINALS:

ENVIRONMENT SPECIFICATIONS: NORMAL OPERATING TEMP.: ENVIRONMENT: RAYCAP RSCAC-6533-P-120-D

10.45 IN (265.43 mm) 10.28 IN (261.11 mm) 7.46 IN (189.48 mm) 1.25 LBS (1.02 kg)

30A 120V 4

COMPRESSION LUGS (6 AWG-14 AWG) TERMINAL BLOCK (10 AWG-26 AWG)

-40°C TO +80°C OUTDOOR CLASS NEMA 4X POLYCARBONATE UL 94V-0 RATED







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ELECTRICAL SEAL

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SHEET TITLE

PANEL SCHEDULE & ELECTRICAL DETAILS

SHEET NUMBER


E2

ELECTRICAL PANEL SCHEDULE

SCALE
N.T.S.

AC DISTRIBUTION PANEL DETAIL

SCALE
N.T.S.

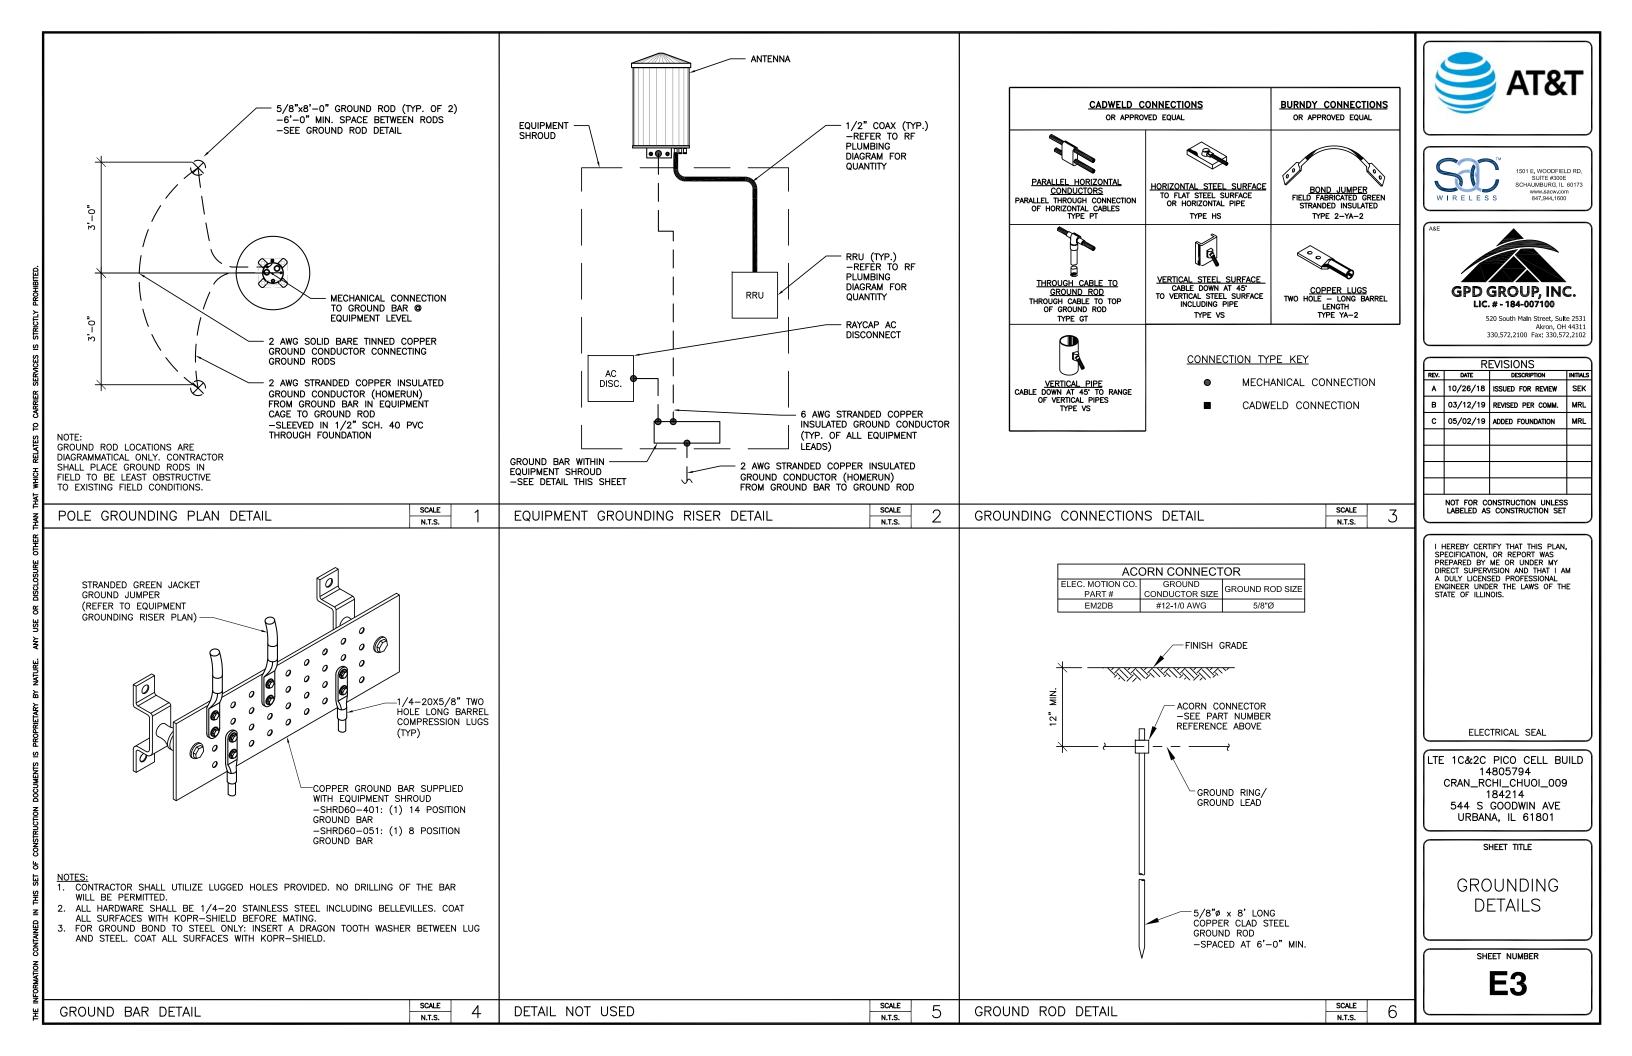

Configuration Name			850 MHz 2T2R LTE	William Artist	and the second					3.5 GHz LAA LTE	and the same		Antenna LAA location
Pico #02	NA	NA	NA	NA	NA	х	NA	NA	X	NA	1	2	14 Ports Antenna

Amphenol Pseudo-Omni – 14 ports Antenna 2C2U3MT360X06Fxys0



Important Note:


For detailed radio to antenna wiring refer to the latest 4T4R Antenna/Radio Port Connection Field Notice (RF-HW-2016-234) and the 4T Wiring Playbook

Two Radios

- B2 (PCS) CEQ.18155
- B66A (AWS) CEQ.18167
 One Radio/One Dummy Radio
- B46 (LAA) CEQ.18245



- HXWXD 17.12" X 7.87" X 4.13"
- WEIGHT 21 LBS.
- POWER CONSUMPTION WATTS MAX
- MINIMUM AC FUSE RATING 8 AMP
- MAX HEAT DISSIPATION 20 WATTS

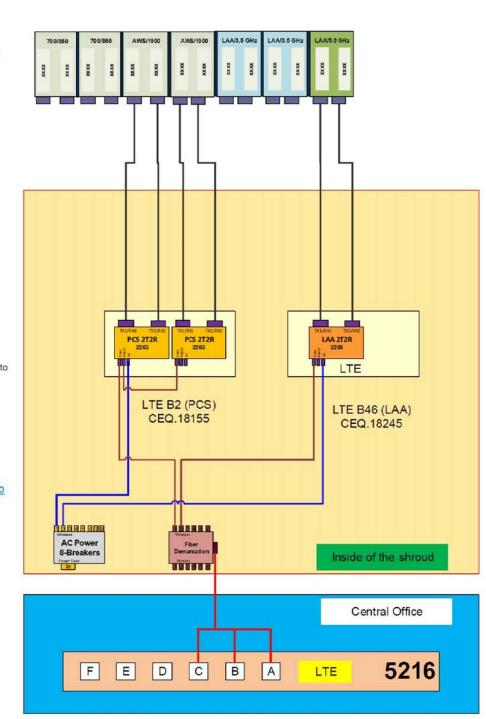





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SHEET TITLE

RF PLUMBING DIAGRAM


SHEET NUMBER

RF1

RF PLUMBING DIAGRAM

SCALE N.T.S.

1

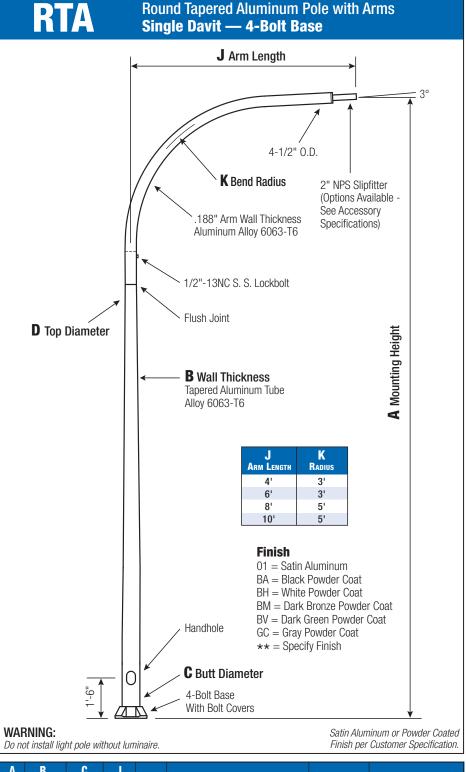

A MTG.	B WALL	С Витт	J Arm	Lum.	āā		XIMUM E		400	Оп	. "
Нст.	THICKNESS	DIAMETER	LENGTH	WEIGHT	90	100	110	120	130	Cat. Number	Catalog Number
30	0.188"	8	10'	35	9.0	6.5	5.7	3.9	2.7	41-160	RTA30D8B4D1A-**

C	D	F	G	H	
Butt Dia.	Top Dia.	Bolt Cir. Dia.	Base Sq.	Bolt Proj.	Bolt Size
8	4.5	11 - 12	11.25	2.75	

Dimensions in Inches

Customer Name:		
Project:	Location:	
Notes:		QUANTITY:

RTA30D8B4D1A

CATALOG NUMBER

FINISH

Pole

Shaft and arm will be constructed of seamless extruded tube of 6063 Aluminum Alloy per the requirements of ASTM B221. The shaft assembly shall be full-length heat treated after base weld to produce a T6 temper.

Base Style

4-Bolt Cast Aluminum Base Flange of Alloy 356-T6 with Aluminum Bolt Covers (Alloy 356-F) and Stainless Steel Hex Head Attaching Screws.




Handhole

Reinforced, 4" x 6" curved Cast Aluminum Frame (Alloy 356-T6) with Aluminum Door and two (2) SS Hex Head Screws. Reinforced Frame will contain a tapped 3/8"-16NC Grounding Provision.

Anchorage

Anchorage Kit will include four (4) L-shaped Steel Anchor Bolts conforming to AASHTO M314-90 Grade 55. Ten inches (10") of threaded end will be galvanized per ASTM A153. Kits will contain four (4) Hex Nuts, four (4) Lock Washers, and four (4) Flat Washers (all components Galvanized Steel). A bolt circle template will be provided.

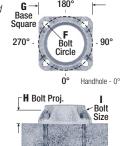

Vibration Damper

When determined necessary by Hapco, a Vibration Damper will be factory-installed inside the pole shaft. Customer specification of the damper is available.



EPA Notes: Effective Projected Area (EPA) in square feet. EPA's calculated using wind velocity (mph) indicated in accordance with 2009 AASHTO LTS-5 using a 25 year design life. Maximum EPA is based on the luminaire weight shown. Increased luminaire weight may reduce the maximum EPA. If weight is exceeded, or if other design life or code is required, please consult the factory.



26252 Hillman Highway Abingdon, VA 24210 800.368.7171 www.hapco.com

PROJECT INFORMATION

SITE NAME: COUNTY: ADDRESS:

CRAN_RCHI_CHNOS_004 CHAMPAIGN 1171 W GREEN ST URBANA, IL 61801

FA NUMBER:

CITY OF URBANA 14805850

3304A0AAQR / 3304A0AARM MRCHI025452 / MRCHI025399

LATITUDE: LONGITUDE: **ELEVATION:**

40° 06' 37.3782" (40.110383°) 88° 13' 23.6742" (-88.223243°)

LIGHT POLE/UTILITY POLE OWNÉR:

CITY OF URBANA

APPLICANT:

AT&T MOBILITY 930 NATIONAL PARKWAY SCHAUMBURG IL 60173

AT&T_PROJECT MANAGER/SITE

ACQUISITION:

VANESSA ROSS (217) 814-2314 VF2021@ATT.COM

AT&T CONSTRUCTION

MANAGER:

CHRISTIANA RACHAL CR630A@ATT.COM

PROJECT CONSULTANTS

PROJECT MANAGER: SAC WIRELESS LLC

540 W. MADISON ST. (9TH FLOOR) CHICAGO IL 60661 CONTACT: PRITI MORE PHONE: (312) 789-4353 EMAIL: PRITI.MORE@SACW.COM

ARCHITECT:

GPD GROUP, INC. — 184—007100 520 S. MAIN ST., SUITE 2531 AKRON, OH 44311

JAMES HOM

SAC C.M. MARK KLEPACKI

EMAIL: MARK.KLEPACKI@SACW.COM

SAC P.M.

EMAIL: JAMES.HOM@SACW.COM

AT&T MOBILITY

PROJECT: LTE 1C&2C MICRO CELL BUILD

SITE #: CRAN_RCHI_CHUOI_023

USID / NODE: 184228 FA #: 14805850

PTN #: 3304A0AAQR / 3304A0AARM PACE #: MRCHI025452 / MRCHI025399


ENODEB NAME: ILL07049F R01 JURISDICTION: CITY OF URBANA

CRAN_RCHI_CHNOS_004 1171 W GREEN ST SITE NAME:

ADDRESS: URBANA, IL 61801

VICINITY MAP LOCATION MAP



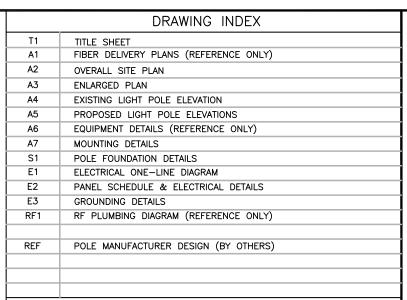

SCOPE OF WORK

THIS IS NOT AN ALL INCLUSIVE LIST. CONTRACTOR SHALL UTILIZE SPECIFIED EQUIPMENT PART OR ENGINEER APPROVED EQUIVALENT. CONTRACTOR SHALL VERIFY ALL NEEDED EQUIPMENT TO PROVIDE A FUNCTIONAL SITE. THE PROJECT GENERALLY CONSISTS OF THE FOLLOWING:

- REMOVE EXISTING LIGHT POLE AND REPLACE WITH NEW 40'-0" HAPCO ALUMINUM DAVIT ARM (DWG# SKDG032619B) LIGHT POLE (BLACK POWDER COAT 5 YR) PER PLAN
- INSTALL NEW ELECTRIC SERVICE RUN FROM EXISTING SOURCE TO NEW LIGHT POLE. METER SUPPLIED & INSTALLED BY CONTRACTOR.
 INSTALL NEW FIBER SERVICE RUN FROM EXISTING SOURCE TO NEW LIGHT
- POLE LOCATION AS SHOWN.
- INSTALL NEW POWER & FIBER EQUIPMENT PER PLAN
- INSTALL (1) NEW OMNI ANTENNA
- INSTALL (1) PCS RRUS-4415 & (1) 700 RRUS-11
- INSTALL CABLING AS REQUIRED
- GROUND AS REQUIRED
- LIGHT POLE LUMINARY TO BE SUPPLIED & INSTALLED BY CONTRACTOR. LUMINARY MUST BE APPROVED BY CITY OF URBANA PRIOR TO ORDER.
- STREET LIGHTING HANDHOLE (IF REQUIRED) SUPPLIED & INSTALLED BY CONTRACTOR
- POTHOLING SHALL BE REQUIRED FOR ANY PROPOSED UTILITY CROSSING HYDROVAC SHALL BE USED FOR ALL TRENCHING & POTHOLING ACTIVITIES CONTRACTOR SHALL MAINTAIN INTEGRITY OF EXISTING POLE DURING REMOVAL & COORDINATE RETURN OF REMOVED POLE TO THE CITY OF URBANA

UTILITY DELIVERY METHOD TO PROPOSED POLE

FIBER - UNDERGROUNDPOWER - UNDERGROUND

CODE COMPLIANCE

- 2015 INTERNATIONAL BUILDING CODE W/CITY AMMENDMENTS
- 2014 NATIONAL ELECTRIC CODE W/CITY AMMENDMENTS

SPECIAL NOTES

- ALL WORK SHALL BE INSTALLED IN CONFORMANCE WITH CURRENT AT&T CONSTRUCTION INSTALLATION GUIDE.
- EXISTING CONDITIONS WILL BE CHANGED & VERIFIED IN FIELD. IF SIGNIFICANT DEVIATIONS OR DETERIORATION ARE ENCOUNTERED AT THE TIME OF CONSTRUCTION, A REPAIR PERMIT WILL BE OBTAINED & CONTRACTOR SHALL NOTIFY ENGINEER IMMEDIATELY.
- THESE DRAWINGS ARE FULL SIZE & SCALEABLE ON 11"X17" SHEET SIZE. STATEMENT THAT COMPLIANCE WITH THE ENERGY CODE IS NOT REQUIRED. -SCOPE OF WORK DOES NOT INVOLVE MODIFICATIONS TO EXTERIOR ENVELOPE OF BUILDING, HVAC SYSTEMS OR ELECTRICAL LIGHTING

DO NOT SCALE DRAWINGS

CONTRACTOR SHALL VERIFY ALL PLANS & EXISTING DIMENSIONS & CONDITIONS ON THE JOB SITE & SHALL IMMEDIATELY NOTIFY THE ARCHITECT OR ENGINEER IN WRITING OF ANY DISCREPANCIES BEFORE PROCEEDING WITH THE WORK OR BE RESPONSIBLE FOR SAME.







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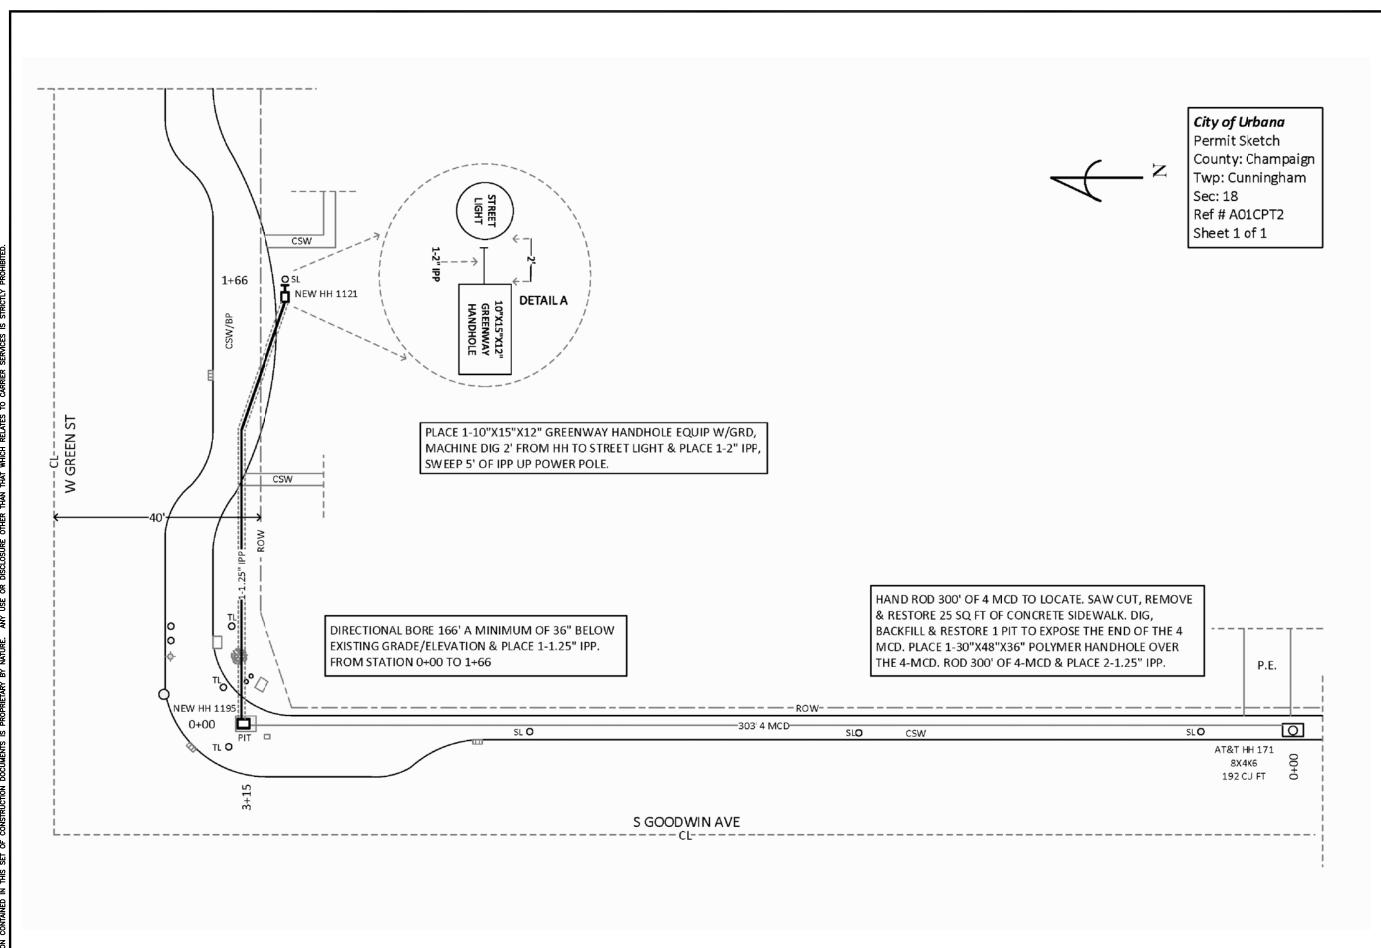
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SHEET TITLE

TITLE SHEET

SHFFT NUMBER

SAC File: T:\ATandT\184228\01 2017732 67 SAC\AE\CD\CRAN_RCHI_CHNOS_004 URBANA CD.dwg 05/02/19 14:11



FIBER DELIVERY PLANS





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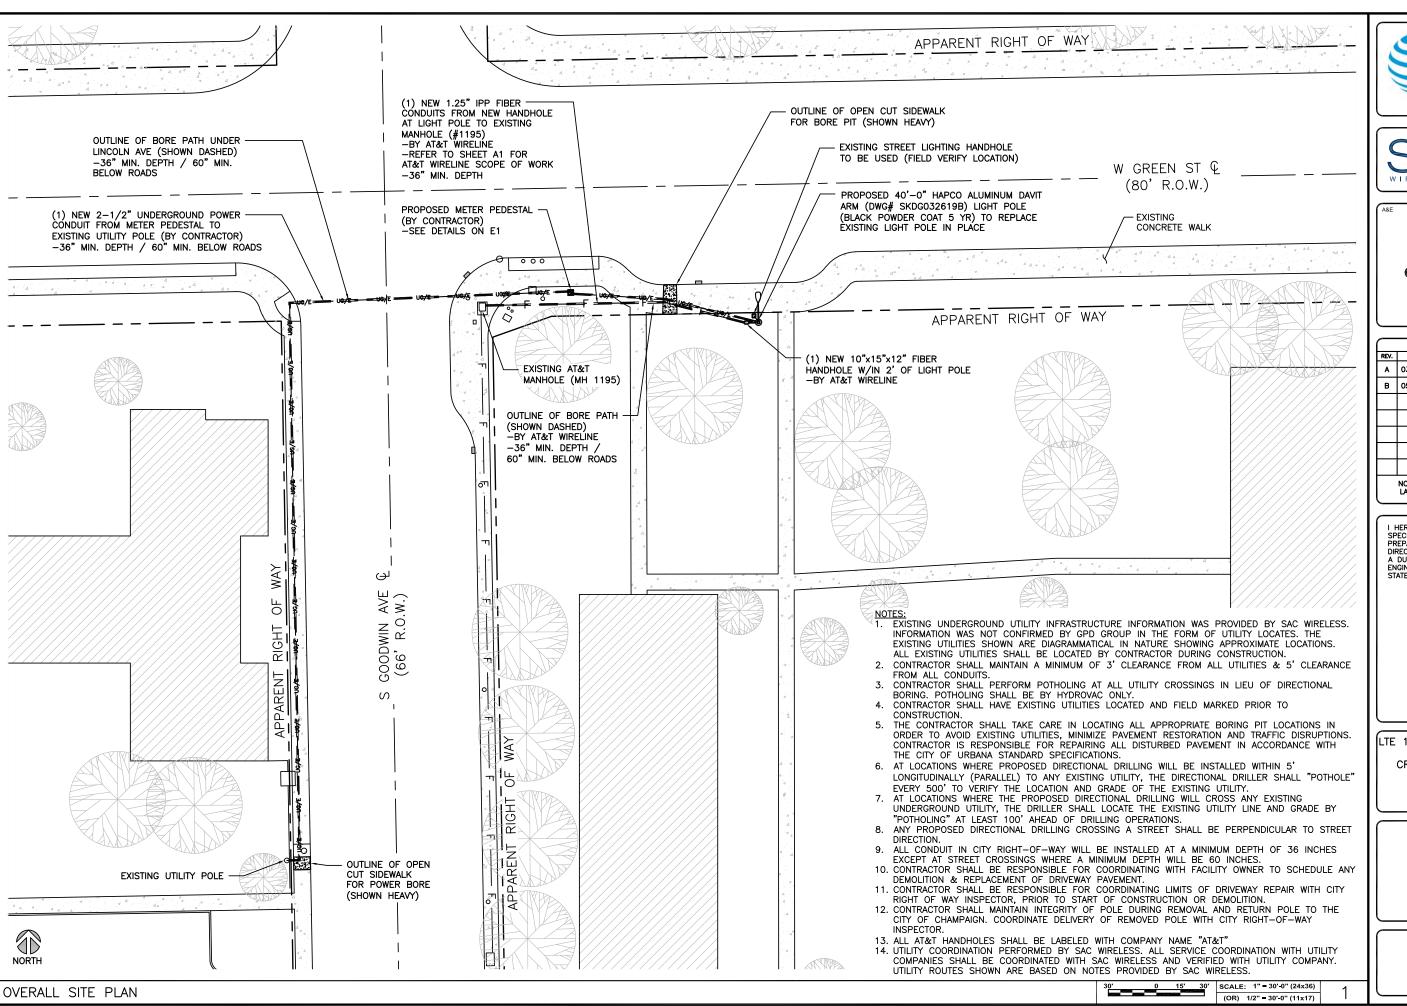
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FIBER DELIVERY PLANS

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A1

SCALE N.T.S.









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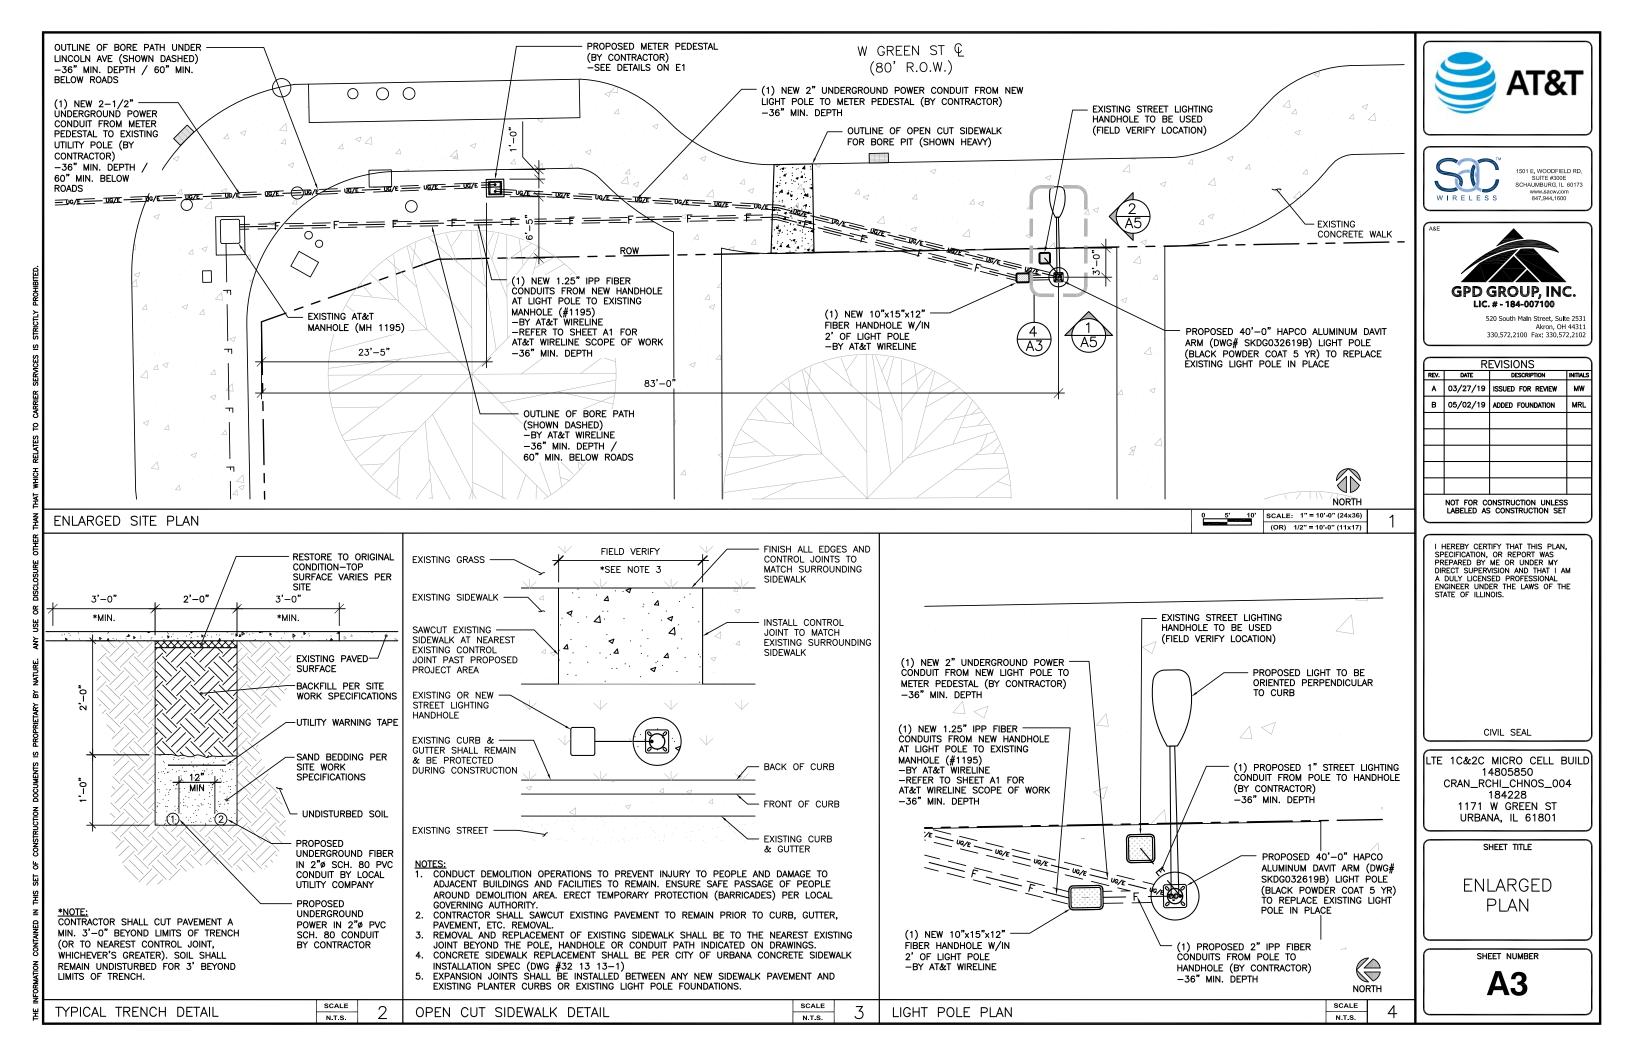
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SHEET TITLE

OVERALL SITE PLAN

SHEET NUMBER

A2









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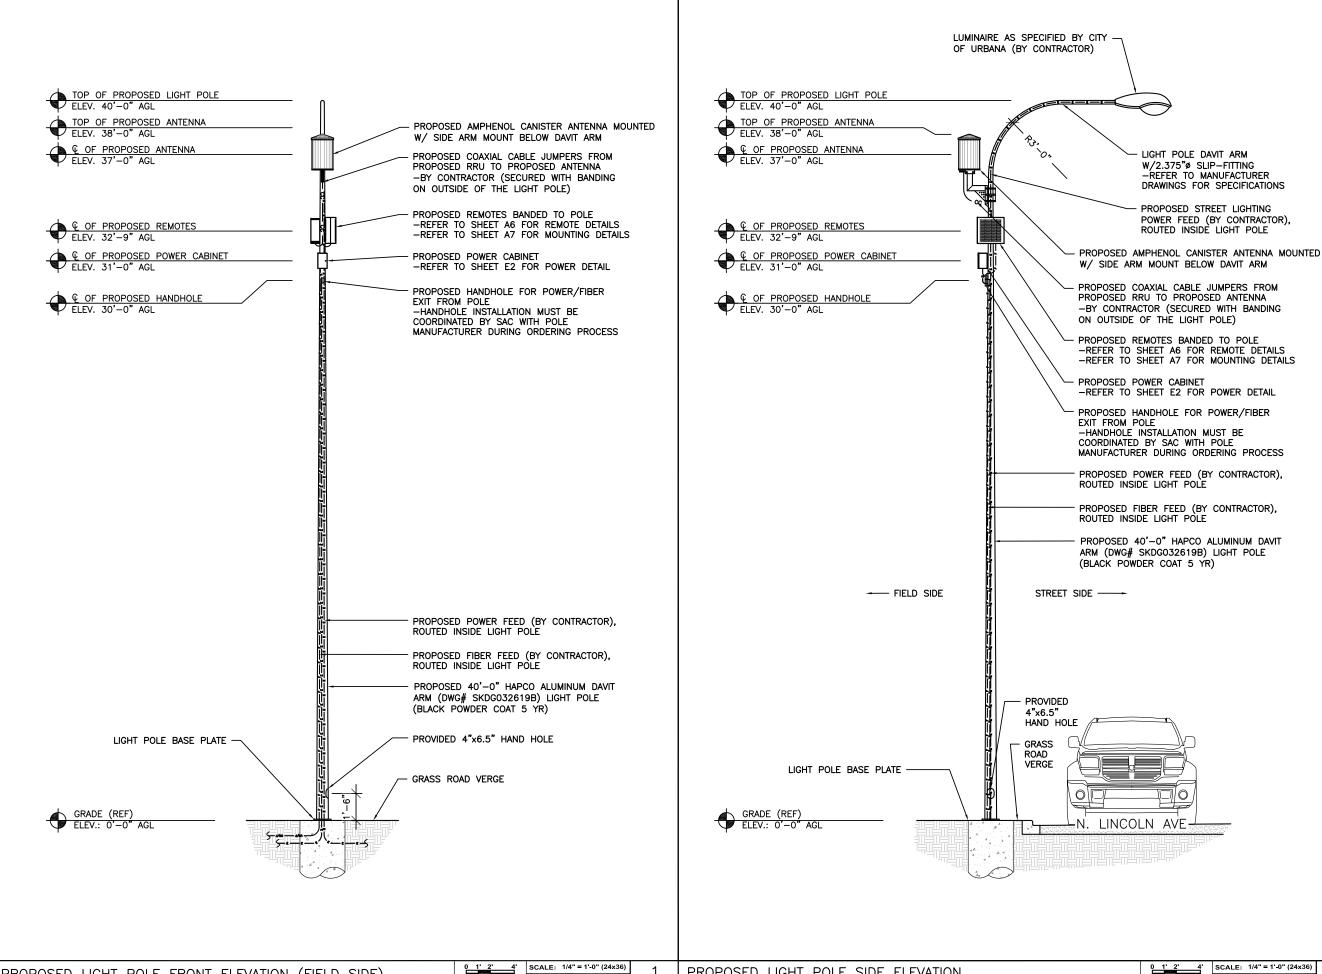
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SHEET TITLE

EXISTING LIGHT POLE ELEVATION

SHEET NUMBER

A4









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SHEET TITLE

PROPOSED LIGHT POLE **ELEVATIONS**

SHEET NUMBER

A5

(OR) 1/8" = 1'-0" (11x17)

PROPOSED LIGHT POLE SIDE ELEVATION

SCALE: 1/4" = 1'-0" (24x36) (OR) 1/8" = 1'-0" (11x17)

2

MANUFACTURER: MODEL:

ERICSSON RRUS 4415 B25


MECHANICAL SPECIFICATIONS: HEIGHT:

14.96 IN (380mm) 13.19 IN (335mm) 5.39 IN (137mm) 46 LBS (21kg) WEIGHT:

INTERFACE SPECIFICATIONS:

2x2.5/4.9/9.8/10.1 Gbps (ONLY USE ERICSSON SUPPLIED AND APPROVED SFPs) 2

EXTERNAL ALARMS:

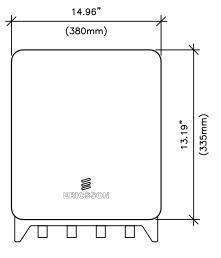



MANUFACTURER: MODEL:

ERICSSON RRUS-11

2x7/16 IEC-169-4

MECHANICAL SPECIFICATIONS: HEIGHT:


19.7 IN (500mm) 17.0 IN (431mm) 7.2 IN (182mm) 50.7 LBS (23kg) WIDTH: DEPTH: WEIGHT:

INTERFACE SPECIFICATIONS: ANTENNA PORTS: OPTICAL INDICATORS: EXTERNAL ALARMS: FIELD GROUND:

ELECTRICAL SPECIFICATIONS: POWER SUPPLY:

-48 VDC OR 100-250 VAC

ENVIRONMENTAL SPECIFICATIONS: NORMAL OPERATING TEMP.: RELATIVE HUMIDITY: -40°C TO +55°C 5-100%

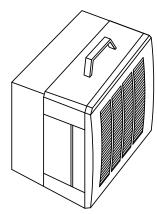



RRUS 4415 B25 DETAILS

SCALE N.T.S.

RRUS-11 DETAILS

SCALE N.T.S.

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NOT FOR CONSTRUCTION UNLESS LABELED AS CONSTRUCTION SET

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GPD GROUP, INC. LIC. # - 184-007100 520 South Maln Street, Sulte 2531 Akron, OH 44311 330.572.2100 Fax: 330.572.2102

REVISIONS REV. DATE DESCRIPTION A 03/27/19 ISSUED FOR REVIEW B 05/02/19 ADDED FOUNDATION

> REFERENCE ONLY

LTE 1C&2C MICRO CELL BUILD 14805850 CRAN_RCHI_CHNOS_004 184228 1171 W GREEN ST URBANA, IL 61801


SHEET TITLE

EQUIPMENT DETAILS


SHEET NUMBER

A6



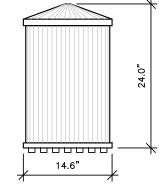

SIDE VIEW

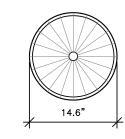

TOP VIEW

IMAGE

AMPHENOL MULTI BAND CANISTER ANTENNA MODEL: 2C2U3MT360X06Fxys0

COLOR NOTE: CONTRACTOR SHALL PAINT ALL EQUIPMENT ATTACHED TO STREETLIGHT POLE TO MATCH POLE

MECHANICAL CHARACTERISTICS

- ANTENNA DIMENSIONS (HEIGHT X DIAMETER) :
- WEIGHT W/OUT MOUNTING BRACKET KIT:
- SURVIVAL WIND SPEED:

- WIND AREA: - WIND LOAD (100 MPH):

24.0"x14.6" TBD LBS 150 MPH 2.4 FT² 43 LBF

DETAIL NOT USED


SCALE

N.T.S.

ANTENNA DETAIL


SCALE: NTS

4

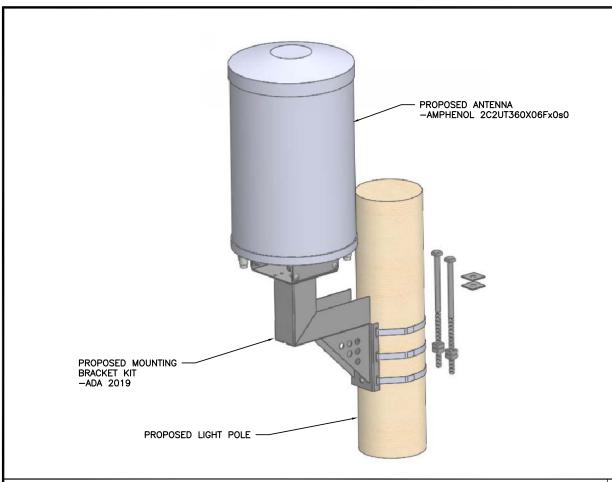

ANTENNA MOUNTING DETAIL

SCALE

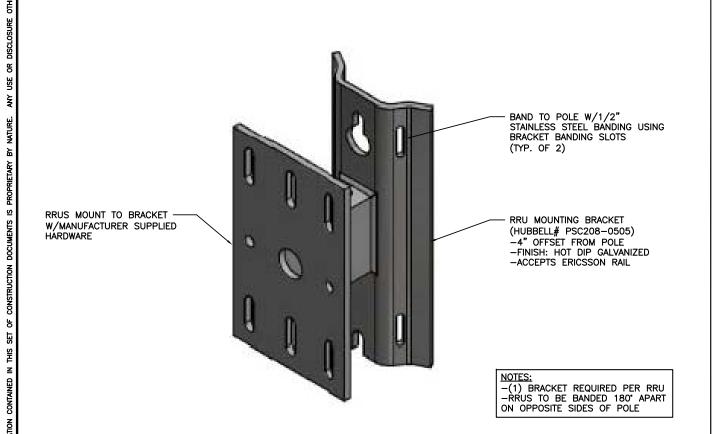


EXAMPLE CRAN RF CAUTION SIGN

A CAUTION A AT&T operates antennas at this structure Above this point you are entering an area where radio frequency (RF) fields may exceed the FCC General Occupational Exposure limits. Follow safety guidelines for working in an RF environment Keep 1 ft. away from the fronts of

Contact AT&T at 800-638-2822, opt. 9, 3 and follow their instructions prior to performing any maintenance or repairs above this point.

Cell Site USID.

EXAMPLE CRAN RF NOTICE SIGN

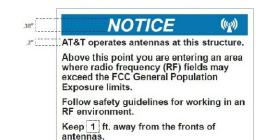

Contact AT&T at 800-638-2822, opt. 9, 3 and follow their instructions prior to performing any maintenance or repairs above this point.

16.5 pt.

This is AT&T Site USID_

EXAMPLE CRAN POLE POWER DISCONNECT SIGN

DISCONNECT AC & DC POWER BOTH BEFORE WORKING ON POLE Contact AT&T at 800-638-2822, opt. 9, 3 and follow their instructions prior to performing any maintenance or repairs above this point.

EXAMPLE STONEHOUSE RD899 RF NOTICE SIGN

NOTICE

RF energy emitted by this antenna may exceed the FCC's exposure limits for the general population.

Stay at least 1 feet away from the antenna.

deployed. It may also be placed on antenna shrouds as shown in Figures 11 and 12.

Cell Site USID

Call AT&T at 800-638-2822, option 9 then 3, for help if you need access within 3 feet. STONEHOUSE RD899

CRAN Pole Power Disconnect, RF Notice, and Caution signs shall be ordered through Stonehouse Signs. Three versions are available for each of the signs shown in Figures 16, 17, and 18: .055 Polyethylene – Reflective, .025 Aluminum – Reflective, and Peel Back Label – Reflective. All versions are 6°x6" with font designed to be visible from 2-3 feet away when approached from below to provide warning about ascending into the high RF exposure areas. The RF Caution sign shown in Figure 19 is designed to be visible from 3 feet away and is available in the reflective peel back label version only. It is designed to fit on most of the CRAN/Small Cell antenna types currently

SIGNAGE NOTE:
SIGNAGE SHALL BE INSTALLED PER AT&T DIRECTION





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	REVISIONS)							
REV.	DATE	DESCRIPTION	INITIALS					
A	03/27/19	ISSUED FOR REVIEW	MW					
В	05/02/19	ADDED FOUNDATION	MRL					

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CIVIL SEAL

LTE 1C&2C MICRO CELL BUILD 14805850 CRAN_RCHI_CHNOS_004 184228 1171 W GREEN ST URBANA, IL 61801


SHEET TITLE

MOUNTING DETAILS

SHEET NUMBER

A7

SCALE 3 RRU MOUNTING DETAIL AT&T SIGNAGE DETAIL SCALE: NTS N.T.S.

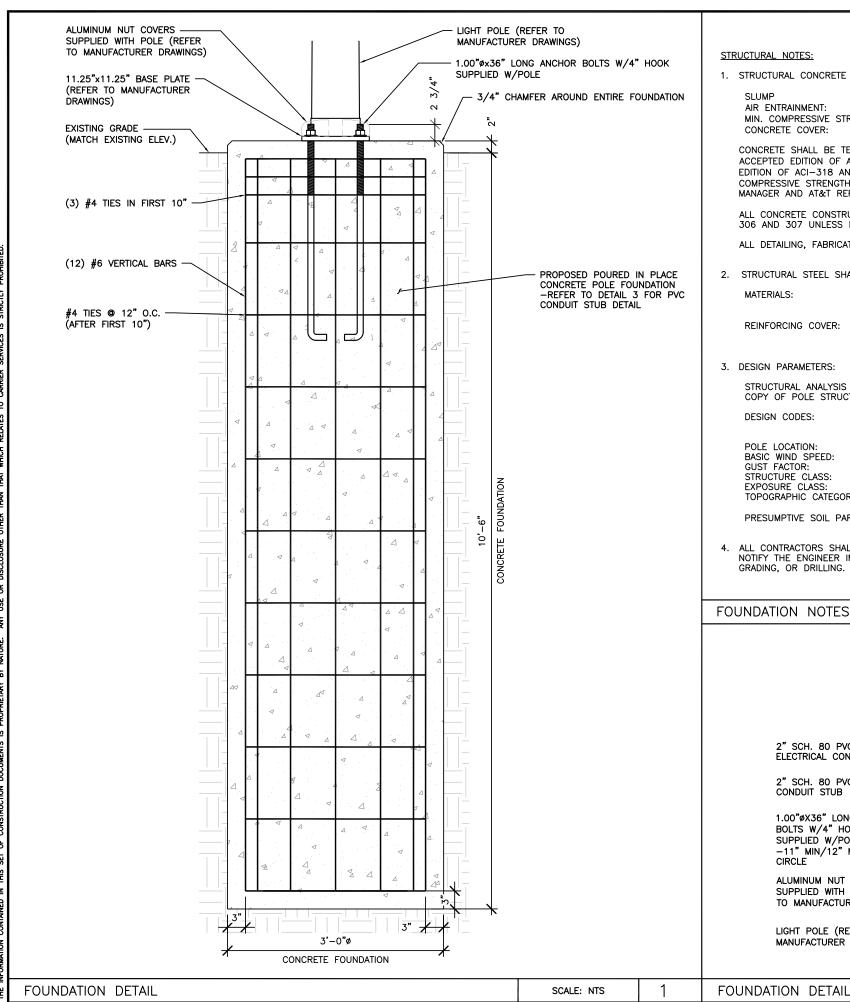

STRUCTURAL NOTES:

1. STRUCTURAL CONCRETE SHALL MEET THE FOLLOWING SPECIFICATIONS:

 $4" (\pm 1")$ AIR ENTRAINMENT: 6% (±1%) MIN. COMPRESSIVE STRENGTH (F'c): 4,500 PSI @ 28 DAYS CONCRETE COVER: 3" ALL SIDES

CONCRETE SHALL BE TESTED BY A REPUTABLE INDEPENDENT THIRD PARTY TESTING AGENCY IN ACCORDANCE WITH LATEST WISCONSIN ACCEPTED EDITION OF ACI-318. FIVE (5) CONCRETE CYLINDERS SHALL BE CAST IN ACCORDANCE WITH LATEST WISCONSIN ACCEPTED EDITION OF ACI-318 AND BE LABORATORY CURED. THE AVERAGE OF THREE (3) CONCRETE CYLINDERS SHALL HAVE A MINIMUM COMPRESSIVE STRENGTH (F'c) OF 4,500 PSI AT 28 DAYS. THE TESTING RESULTS SHALL BE PROVIDED TO THE CONSTRUCTION MANAGER AND AT&T REPRESENTATIVE.

ALL CONCRETE CONSTRUCTION SHALL CONFORM TO ACI*96, "STANDARD SPECIFICATION FOR STRUCTURAL CONCRETE" AND ACI 305, 306 AND 307 UNLESS NOTED OTHERWISE.

ALL DETAILING, FABRICATION AND PLACING OF CONCRETE SHALL CONFORM TO ACI 318-11.

2. STRUCTURAL STEEL SHALL MEET THE FOLLOWING SPECIFICATIONS:

REINFORCING ASTM 615, GRADE 60 MATERIALS: ANCHOR BOLTS ASTM F1554, GRADE 55

REINFORCING COVER: TOP воттом 3"

3. DESIGN PARAMETERS:

STRUCTURAL ANALYSIS OF THE POLE AND FOUNDATION WAS COMPLETED BY OTHERS. COORDINATE WITH SAC WIRELESS FOR A COPY OF POLE STRUCTURAL ANALYSIS.

DESIGN CODES: 2015 INTERNATIONAL BUILDING BUILDING CODE

TIA-222-G

POLE LOCATION: CHAMPAIGN COUNTY, IL

BASIC WIND SPEED: GUST FACTOR: 130 MPH 1.14 STRUCTURE CLASS: CLASS II

EXPOSURE CLASS: TOPOGRAPHIC CATEGORY:

MANUFACTURER DRAWINGS)

PRESUMPTIVE SOIL PARAMETERS: FOUNDATION IS BASED ON AN ALLOWABLE LATERAL BEARING PRESSURE OF AT LEAST 200 PSF/FT.

4. ALL CONTRACTORS SHALL EXERCISE GREAT CARE DURING EXCAVATION. CONTRACTOR SHALL PREDETERMINE UTILITY LOCATIONS AND NOTIFY THE ENGINEER IMMEDIATELY IF DEVIATION FROM PLANS EXIST. CONTRACTOR SHALL CONTACT 811 48 HR. PRIOR TO DIGGING, GRADING, OR DRILLING.

FOUNDATION NOTES

3'-0"ø REINFORCED CONCRETE FOUNDATION 2" SCH. 80 PVC LIGHTING 2" SCH. 80 PVC FIBER ELECTRICAL CONDUIT STUB CONDUIT STUB 2" SCH. 80 PVC ELECTRIC CONDUIT STUB 1.00"øX36" LONG ANCHOR BOLTS W/4" HOOK 1/2" SCH. 80 PVC SUPPLIED W/POLE GROUNDING CONDUIT STUB -11" MIN/12" MAX BOLT CIRCLE ALUMINUM NUT COVERS -SUPPLIED WITH POLE (REFER 11.25"X11.25" BASE PLATE TO MANUFACTURER DRAWINGS) (REFER TO MANUFACTURER DRAWINGS) LIGHT POLE (REFER TO





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В	05/02/19	ADDED FOUNDATION	MRL						
	NOT FOR CONSTRUCTION UNLESS								

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STRUCTURAL SEAL

SCALE

N.T.S.

2

3

SCALE: NTS


LTE 1C&2C MICRO CELL BUILD 14805850 CRAN_RCHI_CHNOS_004 184228 1171 W GREEN ST URBANA, IL 61801


SHEET TITLE

POLE **FOUNDATION** DETAILS

SHEET NUMBER

S1

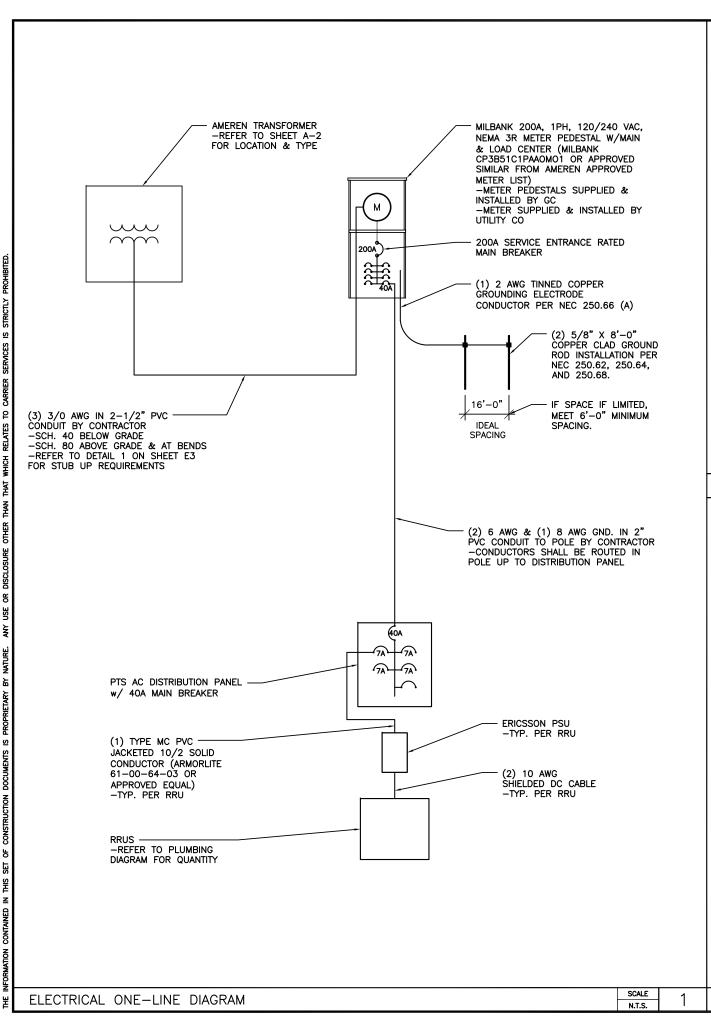

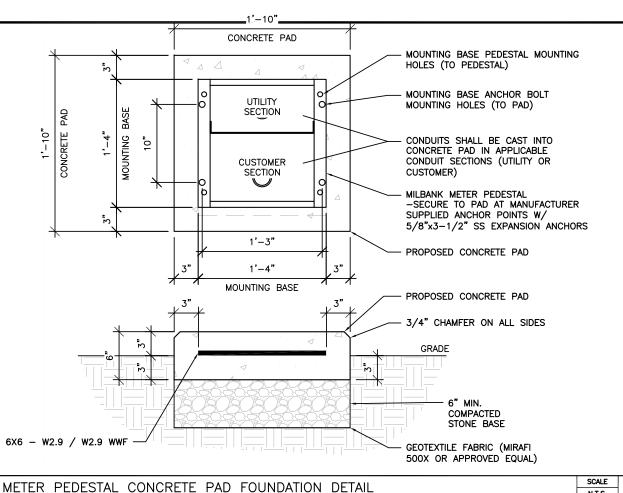

N.T.S.

SCALE

N.T.S.

3

ELECTRICAL NOTES:

- 1. ALL ELECTRICAL WORK SHALL BE IN ACCORDANCE WITH THE PROJECT SPECIFICATIONS AND ALL APPLICABLE CODES.
- 2. CONDUIT ROUTINGS ARE SCHEMATIC. SUBCONTRACTOR SHALL INSTALL CONDUITS SUCH THAT ACCESS TO EQUIPMENT IS NOT BLOCKED.
- 3. SUBCONTRACTOR IS RESPONSIBLE FOR PROPERLY SEQUENCING THE INSTALLATION OF GROUNDING AND UNDERGROUND CONDUIT AS TO PREVENT THE LOSS OF CONTINUITY IN THE GROUNDING SYSTEM OR DAMAGE TO THE CONDUIT.
- 4. COMPRESSION GROUND CONNECTIONS MAY BE REPLACED BY EXOTHERMIC (CADWELD) CONNECTIONS WHEN APPROVED BY CINCINNATI BELL CONSTRUCTION MANAGER.
- 5. SERVICE TO METER PEDESTAL SHALL BE 120/240VAC, 200 AMP, SINGLE PHASE.
- 6. ALL GROUND CONNECTIONS BELOW GRADE SHALL BE EXOTHERMIC (CADWELD).
- 7. ALL GROUND CONNECTIONS ABOVE GRADE SHALL BE FORMED USING TWO (2) HIGH PRESS CRIMPS.
- ALL EXOTHERMIC CONNECTIONS TO THE GROUND RODS SHALL START AT THE TOP AND HAVE A VERTICAL SEPARATION OF 6" FOR EVERY ADDITIONAL CONNECTION.
- 9. ALL EXTERIOR GROUND CONNECTIONS SHALL BE COATED WITH A CORROSION RESISTANT MATERIAL.
- 10. ALL EXTERIOR GROUND CONNECTORS SHALL BE 2 AWG SOLID BARE, TINNED, COPPER UNLESS INDICATED OTHERWISE.
- 11. CONNECTIONS TO THE GROUND BUS SHALL NOT BE DOUBLED UP OR STACKED. BACK TO BACK CONNECTIONS ON OPPOSITE SIDES OF THE GROUND BUS ARE PERMITTED.
- 12. USE OF 90' BENDS IN THE PROTECTION GROUNDING CONDUCTORS SHALL BE AVOIDED WHEN 45' BENDS CAN BE ADEQUATELY SUPPORTED.
- 13. MAXIMUM RESISTANCE OF THE COMPLETED GROUND SYSTEM SHALL NOT EXCEED 5 OHMS. TESTING SHALL BE PERFORMED IN ACCORDANCE WITH PROJECT SPECIFICATIONS FOR FACILITY GROUNDING, USING FALL OF POTENTIAL METHOD.

STANDARD CONDUIT NOTES:

ELECTRICAL NOTES

- 1. UNDERGROUND CONDUIT SHALL BE SCHEDULE 40 PVC. ABOVE GROUND CONDUIT, ELBOWS, AND RISERS SHALL BE SCHEDULE 80 PVC.
- 2. UNDERGROUND SERVICE CONDUIT SHALL MEET REQUIRED BURIAL DEPTH PER AMEREN ELECTRIC SERVICE MANUAL.
- 3. G.C. TO STUB UP SERVICE CONDUIT AT UTILITY POLE WITH 90' SWEEPING ELBOW. GC. SHALL COIL SUFFICIENT CONDUCTOR TO REACH SERVICE CONNECTION ON POLE. G.C. SHALL SUPPLY ENOUGH CONDUIT AND RISER HARDWARE FOR AMEREN TO EXTEND SERVICE RISER UP POLE TO SERVICE CONNECTION POINT. REFER TO AMEREN ELECTRIC SERVICE MANUAL FOR REQUIREMENTS.
- 4. ALL CONDUIT WILL BE EQUIPPED WITH 3/8" PULL ROPE AND HAVE A TRACER WIRE. TRACER WIRE NEEDS TO BE LAID ABOVE BURIED CONDUIT.







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	В	05/02/19	ADDED FOUNDATION	MRL
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		NOT FOR CO	ONSTRUCTION UNLESS	 S

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ELECTRICAL SEAL


LTE 1C&2C MICRO CELL BUILD 14805850 CRAN_RCHI_CHNOS_004 184228 1171 W GREEN ST URBANA, IL 61801

SHEET TITLE

ELECTRICAL ONE-LINE DIAGRAM

SHEET NUMBER

E1

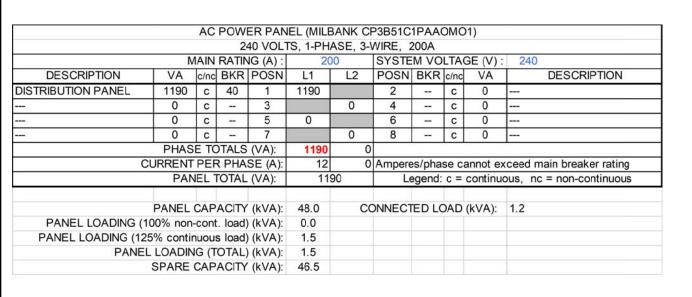

MANUFACTURER: MODEL: MILBANK CP3B51C1PAAOMO1 ELECTRICAL SPECIFICATIONS: AMPERAGE RATING:


200 A 240 V 1 PH AMPERAGE RATING:
OPERATING VOLTAGE:
ELECTRICAL PHASE:
MAIN BREAKER SIZE:
QTY OF BRANCH CIRCUITS:
LINE SIDE WIRE RANGE: 200 A 20 6 AWG - 350 kcmil

ENVIRONMENT SPECIFICATIONS: UL LISTED: NEMA RATING

ADDITIONAL SPECIFICATIONS:
ON AMEREN ENERGY APPROVED LIST (SECTION 1100 OF ELECTRIC SERVICE MANUAL, DATED JANUARY 18, 2018)



"A" Style 16" Metered Commercial Pedestal

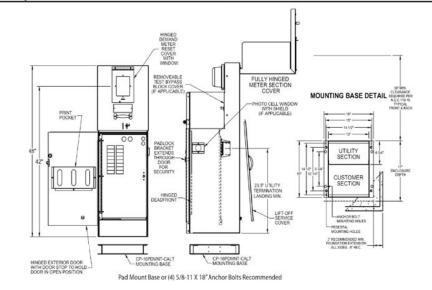

SPECIAL NOTE:
METER PEDESTAL SHALL BE PAINTED TO MATCH AT&T EQUIPMENT IN
RIGHT OF WAY. CONTRACTOR SHALL COORDINATE W/AT&T FOR COLOR
AND PROVIDE DOCUMENTATION OF SUCH TO CITY OF URBANA FOR

ELECTRICAL MAIN & LOAD CENTER PANEL SCHEDULE

SCALE N.T.S.

AC METER SOCKET W/MAIN & LOAD CENTER DETAIL

SCALE N.T.S.

AC POWER PANEL (RAYCAP RSCAC-6533-P-120-D) 120 VOLTS, 1-PHASE, 2-WIRE, 40A MAIN RATING (A) 40 SYSTEM VOLTAGE (V): DESCRIPTION VA c/nc BKR POSN L1 L2 POSN BKR c/nc VA DESCRIPTION RRUS-11 520 c SPARE 520 2 c 0 RRUS-4415 SPARE 670 c 0 7 670 4 7 C SPARE 7 0 PHASE TOTALS (VA): 520 670 CURRENT PER PHASE (A): 7 Amperes/phase cannot exceed main breaker rating PANEL TOTAL (VA): 1190 Legend: c = continuous, nc = non-continuous PANEL CAPACITY (kVA): CONNECTED LOAD (kVA): 1.2 PANEL LOADING (100% non-cont. load) (kVA): PANEL LOADING (125% continuous load) (kVA): 1.5 PANEL LOADING (TOTAL) (kVA): 1.5 SPARE CAPACITY (kVA): 3.3

MANUFACTURER: MODEL: MECHANICAL SPECIFICATIONS: HEIGHT:

WIDTH: DEPTH: WEIGHT:

10.13 IN
06.15 IN
06.00 IN
10 LBS
BANDED TO POLE W/1/2"
STAINLESS STEEL BANDING
THROUGH MANUFACTURER
SUPPLIED POLE MOUNTING
BRACKET

PTS PTS90120


BRACKET

-40°C TO +60°C

ELECTRICAL SPECIFICATIONS: AMPERAGE: OPERATING VOLTAGE:
QTY OF PROTECTED CIRCUITS:

ENVIRONMENT SPECIFICATIONS: NORMAL OPERATING TEMP.:



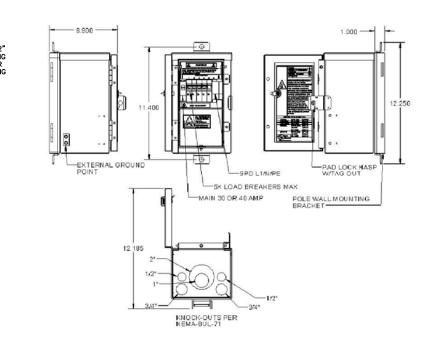





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ELECTRICAL SEAL

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SHEET TITLE


IPANEL SCHEDULE & ELECTRICAL DETAILS

SHEET NUMBER

4

E2

SCALE SCALE AC DISTRIBUTION PANEL DETAIL ELECTRICAL PANEL SCHEDULE N.T.S. N.T.S.

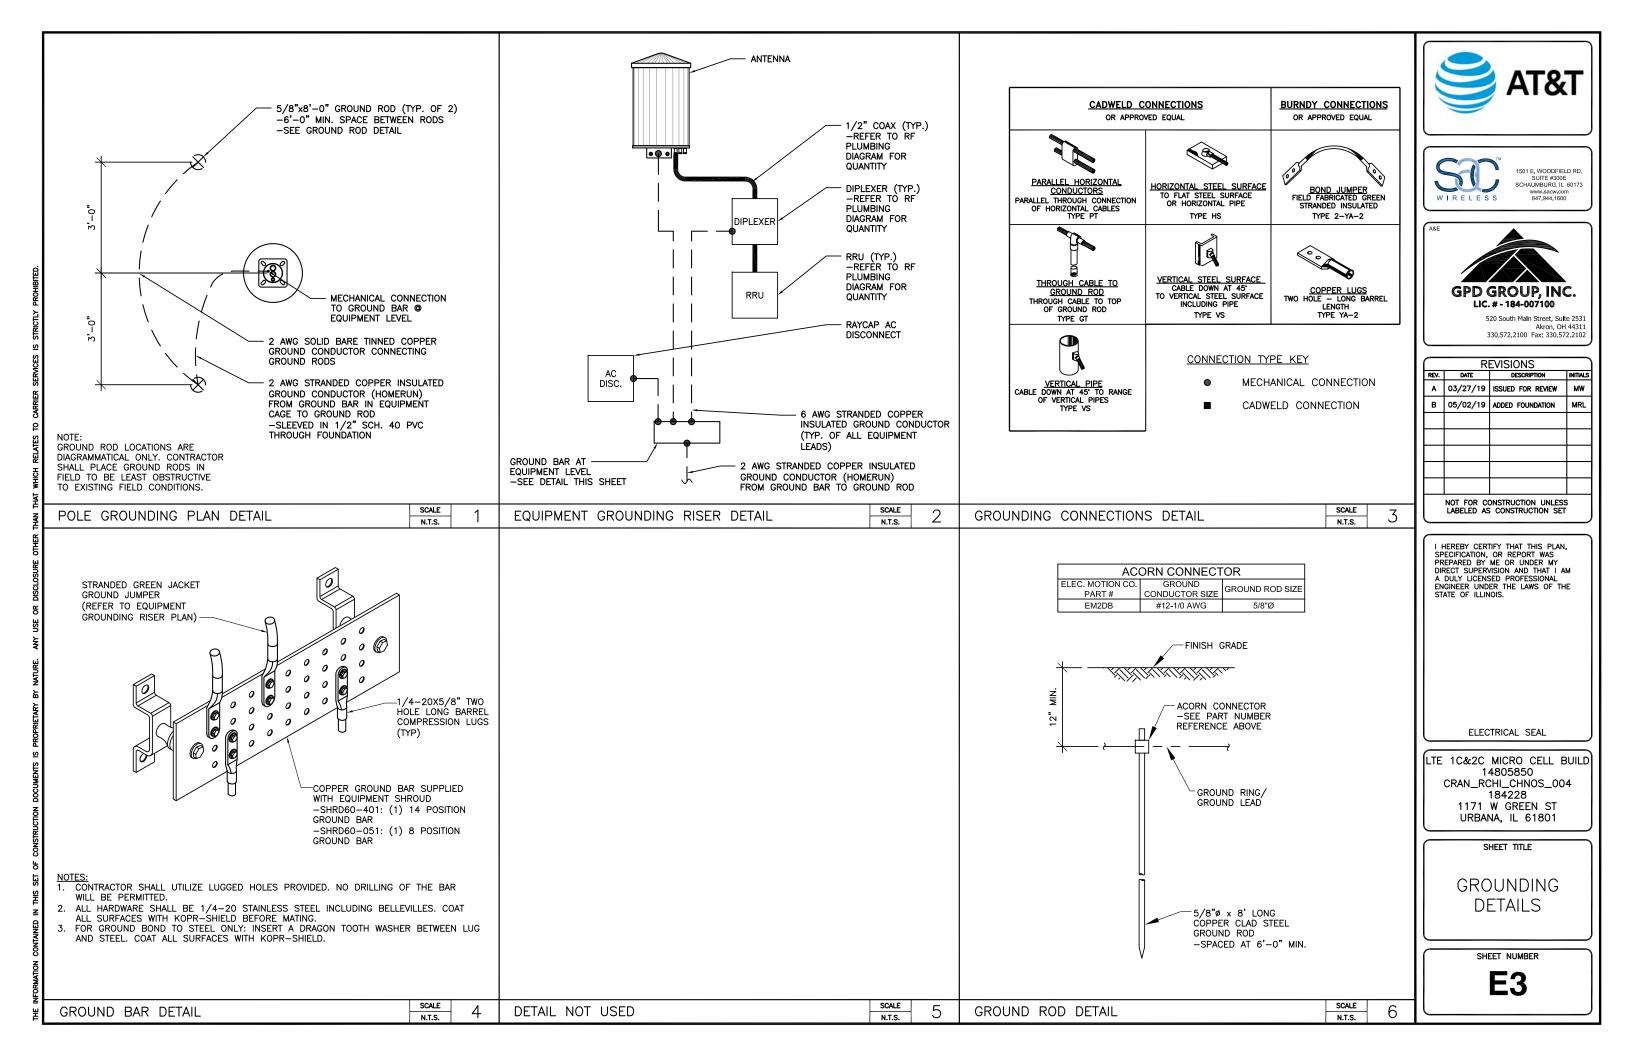


Configuration Name			850 MHz 2T2R LTE					THE PARTY OF THE P		3.5 GHz LAA LTE		The second second	
Micro #17	Х	NA	NA	NA	NA	Х	NA	NA	NA	NA	1	2	14 Ports Antenna





Important Note:

For detailed radio to antenna wiring refer to the latest 4T4R Antenna/Radio Port Connection Field Notice (RF-HW-2016-234) and the 4T Wiring Playbook

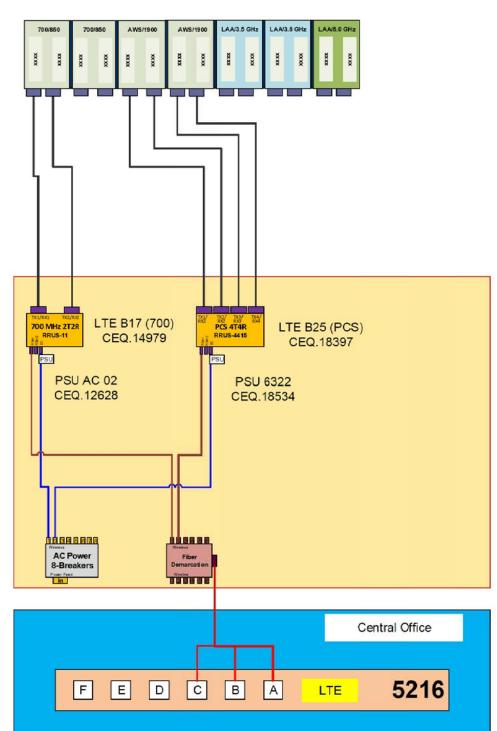





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SHEET TITLE


RF PLUMBING DIAGRAM

SHEET NUMBER

RF1

RF PLUMBING DIAGRAM

SCALE N.T.S. , |||

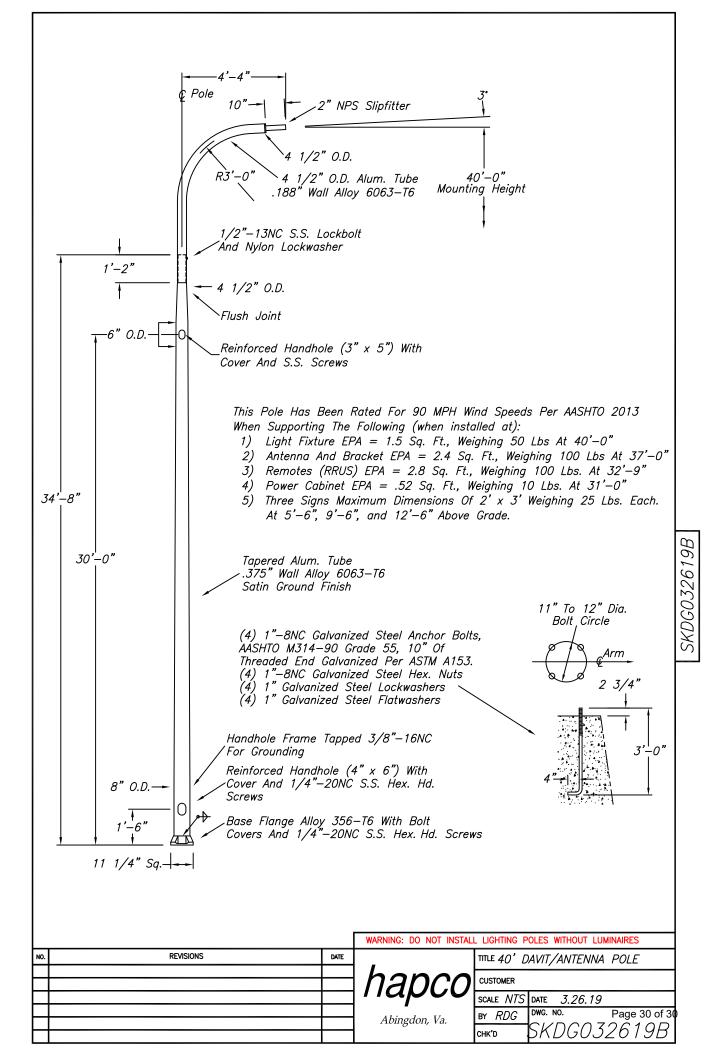

PROJECT INFORMATION

SITE NAME: COUNTY: ADDRESS:

CRAN_RCHI_CHUOI_014 CHAMPAIGN 1189 S VINE ST URBANA, IL 61801 CITY OF URBANA

FA NUMBER:

14805799 3304A0AAPB / 3304A0AARX MRCHI025394 / MRCHI025420

LATITUDE: LONGITUDE: **ELEVATION:**

40° 06' 10.62" (40.10295°) 88° 12' 18.28" (-88.205078°) 7.31

LIGHT POLE/UTILITY POLE OWNÉR:

CITY OF URBANA

APPLICANT:

AT&T MOBILITY 930 NATIONAL PARKWAY SCHAUMBURG IL 60173

AT&T_PROJECT

MANAGER/SITE ACQUISITION:

CONSTANCE LAMBERES (847) 330-3427 CL644H@ATT.COM

AT&T CONSTRUCTION

MANAGER:

CHRISTIANA RACHAL CR630A@ATT.COM

PROJECT CONSULTANTS

PROJECT MANAGER: SAC WIRELESS LLC

> 540 W. MADISON ST. (9TH FLOOR) CHICAGO IL 60661 CONTACT: PRITI MORE PHONE: (312) 789-4353 EMAIL: PRITI.MORE@SACW.COM

ARCHITECT:

GPD GROUP, INC. — 184—007100 520 S. MAIN ST., SUITE 2531 AKRON, OH 44311

SAC C.M. MARK KLEPACKI

EMAIL: MARK.KLEPACKI@SACW.COM

SAC P.M.

EMAIL: JAMES.HOM@SACW.COM

JAMES HOM

AT&T MOBILITY

PROJECT: LTE 1C&2C MICRO CELL BUILD

SITE #: CRAN_RCHI_CHUOI_014

USID / NODE: 184219 FA #: 14805799


PTN #: 3304A0AAPB / 3304A0AARX PACE #: MRCHI025394 / MRCHI025420

ENODEB NAME: ILL07045F R01 JURISDICTION: CITY OF URBANA

SITE NAME: CRAN_RCHI_CHUOI_014

1189 S VINE ST **ADDRESS:**

URBANA, IL 61801

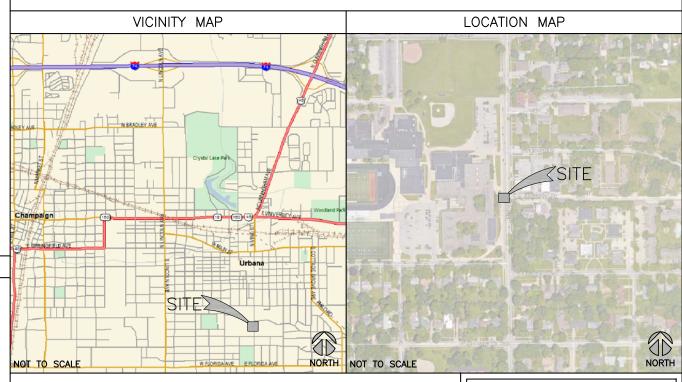



Know what's below. now what's below.

Call before you dig.

REQUIRES MIN OF 2
WORKING DAYS NOTICE
BEFORE YOU EXCAVATION

	DRAWING INDEX
T1	TITLE SHEET
A1	FIBER DELIVERY PLANS (REFERENCE ONLY)
A2	OVERALL SITE PLAN
A3	ENLARGED PLAN
A4	EXISTING LIGHT POLE ELEVATION
A5	PROPOSED LIGHT POLE ELEVATIONS
A6	EQUIPMENT DETAILS (REFERENCE ONLY)
A7	MOUNTING DETAILS
S1	POLE FOUNDATION DETAILS
E1	ELECTRICAL ONE-LINE DIAGRAM
E2	PANEL SCHEDULE & ELECTRICAL DETAILS
E3	GROUNDING DETAILS
RF1	RF PLUMBING DIAGRAM (REFERENCE ONLY)
REF	POLE MANUFACTURER DESIGN (BY OTHERS)
	SCOPE OF WORK

SCOPE OF WORK

THIS IS NOT AN ALL INCLUSIVE LIST. CONTRACTOR SHALL UTILIZE SPECIFIED EQUIPMENT PART OR ENGINEER APPROVED EQUIVALENT. CONTRACTOR SHALL VERIFY ALL NEEDED EQUIPMENT TO PROVIDE A FUNCTIONAL SITE. THE PROJECT GENERALLY CONSISTS OF THE FOLLOWING:

- REMOVE EXISTING LIGHT POLE AND REPLACE WITH NEW 40'-0" HAPCO RTA
- DAVIT ARM LIGHT POLE (100 GRIT SATIN FINISH) PER PLAN
 INSTALL NEW FIBER SERVICE RUN FROM EXISTING SOURCE TO NEW LIGHT POLE LOCATION (TO BE COORDINATED W/AT&T)
- INSTALL NEW POWER & FIBER EQUIPMENT PER PLAN
- INSTALL (1) NEW OMNI ANTENNA - INSTALL (1) PCS RRUS-4415 & (1) 700 RRUS-11 - INSTALL CABLING AS REQUIRED
- GROUND AS REQUIRED
- LIGHT POLE LUMINARY TO BE SUPPLIED & INSTALLED BY CONTRACTOR. LUMINARY MUST BE APPROVED BY CITY OF URBANA PRIOR TO ORDER. STREET LIGHTING HANDHOLE (IF REQUIRED) SUPPLIED & INSTALLED BY
- POTHOLING SHALL BE REQUIRED FOR ANY PROPOSED UTILITY CROSSING
- HYDROVAC SHALL BE USED FOR ALL TRENCHING & POTHOLING ACTIVITIES CONTRACTOR SHALL MAINTAIN INTEGRITY OF EXISTING POLE DURING REMOVAL & COORDINATE RETURN OF REMOVED POLE TO THE CITY OF URBANA

UTILITY DELIVERY METHOD TO PROPOSED POLE — FIBER — UNDERGROUND

- POWER - UNDERGROUND

CODE COMPLIANCE

- 2015 INTERNATIONAL BUILDING CODE W/CITY AMMENDMENTS
- 2014 NATIONAL ELECTRIC CODE W/CITY AMMENDMENTS

SPECIAL NOTES

- ALL WORK SHALL BE INSTALLED IN CONFORMANCE WITH CURRENT AT&T CONSTRUCTION INSTALLATION GUIDE.
- EXISTING CONDITIONS WILL BE CHANGED & VERIFIED IN FIELD. IF SIGNIFICANT DEVIATIONS OR DETERIORATION ARE ENCOUNTERED AT THE TIME OF CONSTRUCTION, A REPAIR PERMIT WILL BE OBTAINED & CONTRACTOR SHALL NOTIFY ENGINEER IMMEDIATELY.
- THESE DRAWINGS ARE FULL SIZE & SCALEABLE ON 11"X17" SHEET SIZE. STATEMENT THAT COMPLIANCE WITH THE ENERGY CODE IS NOT REQUIRED. -SCOPE OF WORK DOES NOT INVOLVE MODIFICATIONS TO EXTERIOR ENVELOPE OF BUILDING, HVAC SYSTEMS OR ELECTRICAL LIGHTING

DO NOT SCALE DRAWINGS

CONTRACTOR SHALL VERIFY ALL PLANS & EXISTING DIMENSIONS & CONDITIONS ON THE JOB SITE & SHALL IMMEDIATELY NOTIFY THE ARCHITECT OR ENGINEER IN WRITING OF ANY DISCREPANCIES BEFORE PROCEEDING WITH THE WORK OR BE RESPONSIBLE FOR SAME.









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CIVIL SEAL


LTE 1C&2C MICRO CELL BUILD 14805799 CRAN_RCHI_CHUOI_014 184219 1189 S VINE ST URBANA, IL 61801

SHEET TITLE


TITLE SHEET

SHEET NUMBER

SAC File: T:\ATandT\184219\01 2017732 66 SAC\AE\CD\CRAN_RCHI_CHUOI_014 CD.dwg 05/02/19 12:17

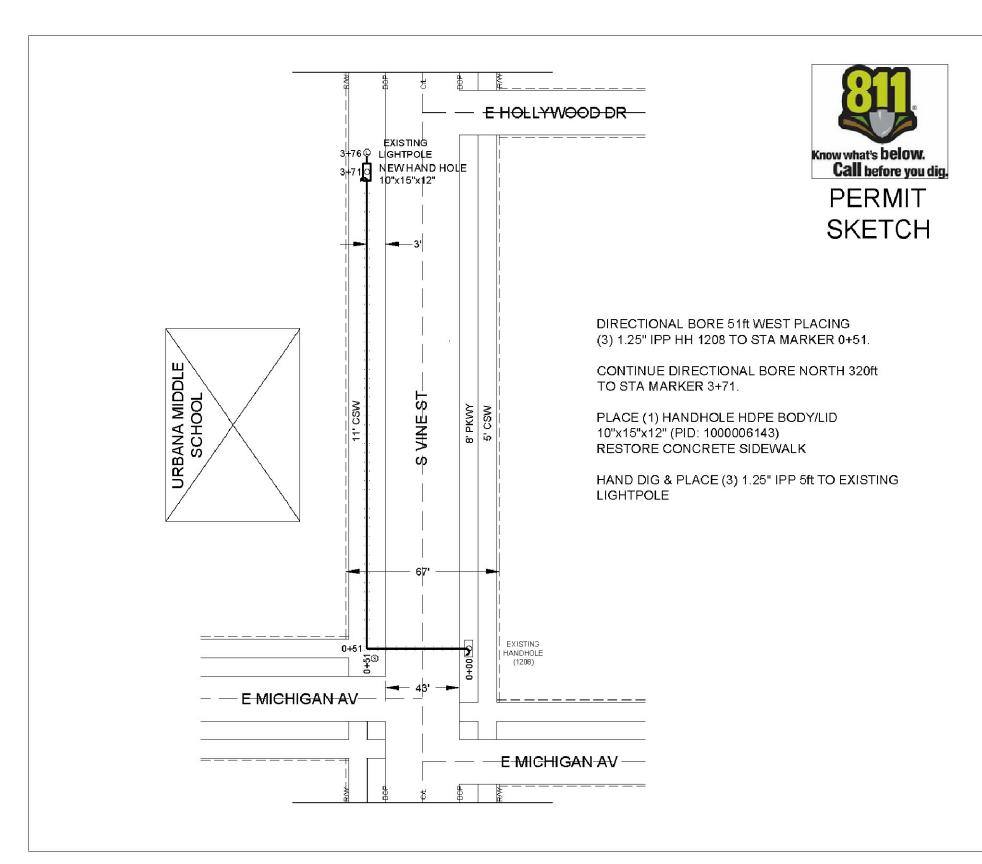

LOCATION MAP

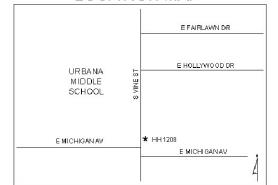

CONSTRUCTION NOTES:

- 1) LOCATE ALL UTILITIES AND ALL UNDERGROUND OBSTRUCTIONS PRIOR TO DIGGING
- 2) WORK AREA PROTECTION REQUIRED
- 3) PLACE AT&T ID DECALS AT REQUIRED LOCATIONS
- 4) RESTORE ALL DISTURBED GROUNDS TO ORIGINAL OR BETTER CONDITION
- 5) AT&T REQUIRES A MINIMUM DEPTH OF 24"
- 6) AT&T CONTRACTORS TO PROVIDE ALL BARRICADES AND WORK AREA PROTECTIONS
- 7) AT&T CONTRACTOR TO REMOVE ALL DEBRIS
- 8) ALL PROPOSED WORK IS IN EXISTING PUBLIC RIGHT OF WAY AND/OR UTILITY EASEMENT

MUNICIPAL PERMIT

1189 S VINE ST URBANA, IL

Z

AT&T PROJECT: A01BRS8 JAMES DARR 1640 E HAZEL DELL RD FLR. 1 SPRINGFIELD, IL 62703 (W) 217-789-8771 (C) 217-320-8146

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SHEET TITLE

FIBER DELIVERY PLANS

SHEET NUMBER


A1

FIBER DELIVERY PLANS (PROVIDED BY AT&T)

SCALE N.T.S.

-

- NOTES:
 1. EXISTING UNDERGROUND UTILITY INFRASTRUCTURE INFORMATION WAS PROVIDED BY SAC WIRELESS. INFORMATION WAS NOT CONFIRMED BY GPD GROUP IN THE FORM OF UTILITY LOCATES. THE EXISTING UTILITIES SHOWN ARE DIAGRAMMATICAL IN NATURE SHOWING APPROXIMATE LOCATIONS. ALL EXISTING UTILITIES SHALL BE LOCATED BY CONTRACTOR DURING CONSTRUCTION.
- 2. CONTRACTOR SHALL MAINTAIN A MINIMUM OF 3' CLEARANCE FROM ALL UTILITIES & 5' CLEARANCE FROM ALL CONDUITS.
- CONTRACTOR SHALL PERFORM POTHOLING AT ALL UTILITY CROSSINGS IN LIEU OF DIRECTIONAL BORING. POTHOLING SHALL BE BY HYDROVAC ONLY.
 CONTRACTOR SHALL HAVE EXISTING UTILITIES LOCATED AND FIELD MARKED PRIOR
- THE CONTRACTOR SHALL TAKE CARE IN LOCATING ALL APPROPRIATE BORING PIT LOCATIONS IN ORDER TO AVOID EXISTING UTILITIES, MINIMIZE PAVEMENT RESTORATION AND TRAFFIC DISRUPTIONS. CONTRACTOR IS RESPONSIBLE FOR REPAIRING ALL DISTURBED PAVEMENT IN ACCORDANCE WITH THE CITY OF URBANA STANDARD SPECIFICATIONS.
- AT LOCATIONS WHERE PROPOSED DIRECTIONAL DRILLING WILL BE INSTALLED WITHIN 5' LONGITUDINALLY (PARALLEL) TO ANY EXISTING UTILITY, THE DIRECTIONAL DRILLER SHALL "POTHOLE" EVERY 500' TO VERIFY THE LOCATION AND GRADE OF THE EXISTING UTILITY.
- AT LOCATIONS WHERE THE PROPOSED DIRECTIONAL DRILLING WILL CROSS ANY EXISTING UNDERGROUND UTILITY, THE DRILLER SHALL LOCATE THE EXISTING UTILITY LINE AND GRADE BY "POTHOLING" AT LEAST 100' AHEAD OF DRILLING
- ANY PROPOSED DIRECTIONAL DRILLING CROSSING A STREET SHALL BE PERPENDICULAR TO STREET DIRECTION.
- ALL CONDUIT IN CITY RIGHT-OF-WAY WILL BE INSTALLED AT A MINIMUM DEPTH OF 36 INCHES EXCEPT AT STREET CROSSINGS WHERE A MINIMUM DEPTH WILL BE 60 INCHES.
- 10. CONTRACTOR SHALL BE RESPONSIBLE FOR COORDINATING WITH FACILITY OWNER TO SCHEDULE ANY DEMOLITION & REPLACEMENT OF DRIVEWAY PAVEMENT.
- CONTRACTOR SHALL BE RESPONSIBLE FOR COORDINATING LIMITS OF DRIVEWAY REPAIR WITH CITY RIGHT OF WAY INSPECTOR, PRIOR TO START OF CONSTRUCTION OR DEMOLITION.
- 12. CONTRACTOR SHALL MAINTAIN INTEGRITY OF POLE DURING REMOVAL AND RETURN POLE TO THE CITY OF CHAMPAIGN. COORDINATE DELIVERY OF REMOVED POLE WITH CITY RIGHT-OF-WAY INSPECTOR.
- 13. ALL AT&T HANDHOLES SHALL BE LABELED WITH COMPANY NAME "AT&T"

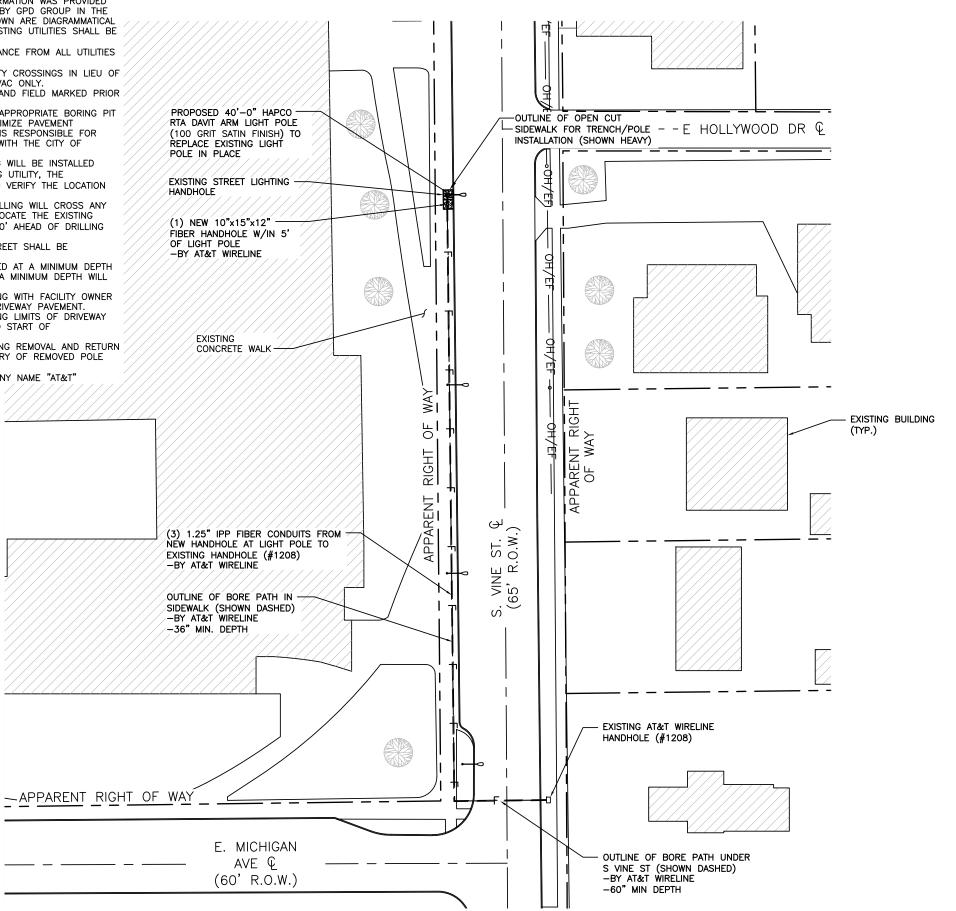







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CIVIL SEAL


LTE 1C&2C MICRO CELL BUILD 14805799 CRAN_RCHI_CHUOI_014 184219 1189 S VINE ST URBANA, IL 61801

SHEET TITLE

OVERALL SITE PLAN

SHEET NUMBER

A2

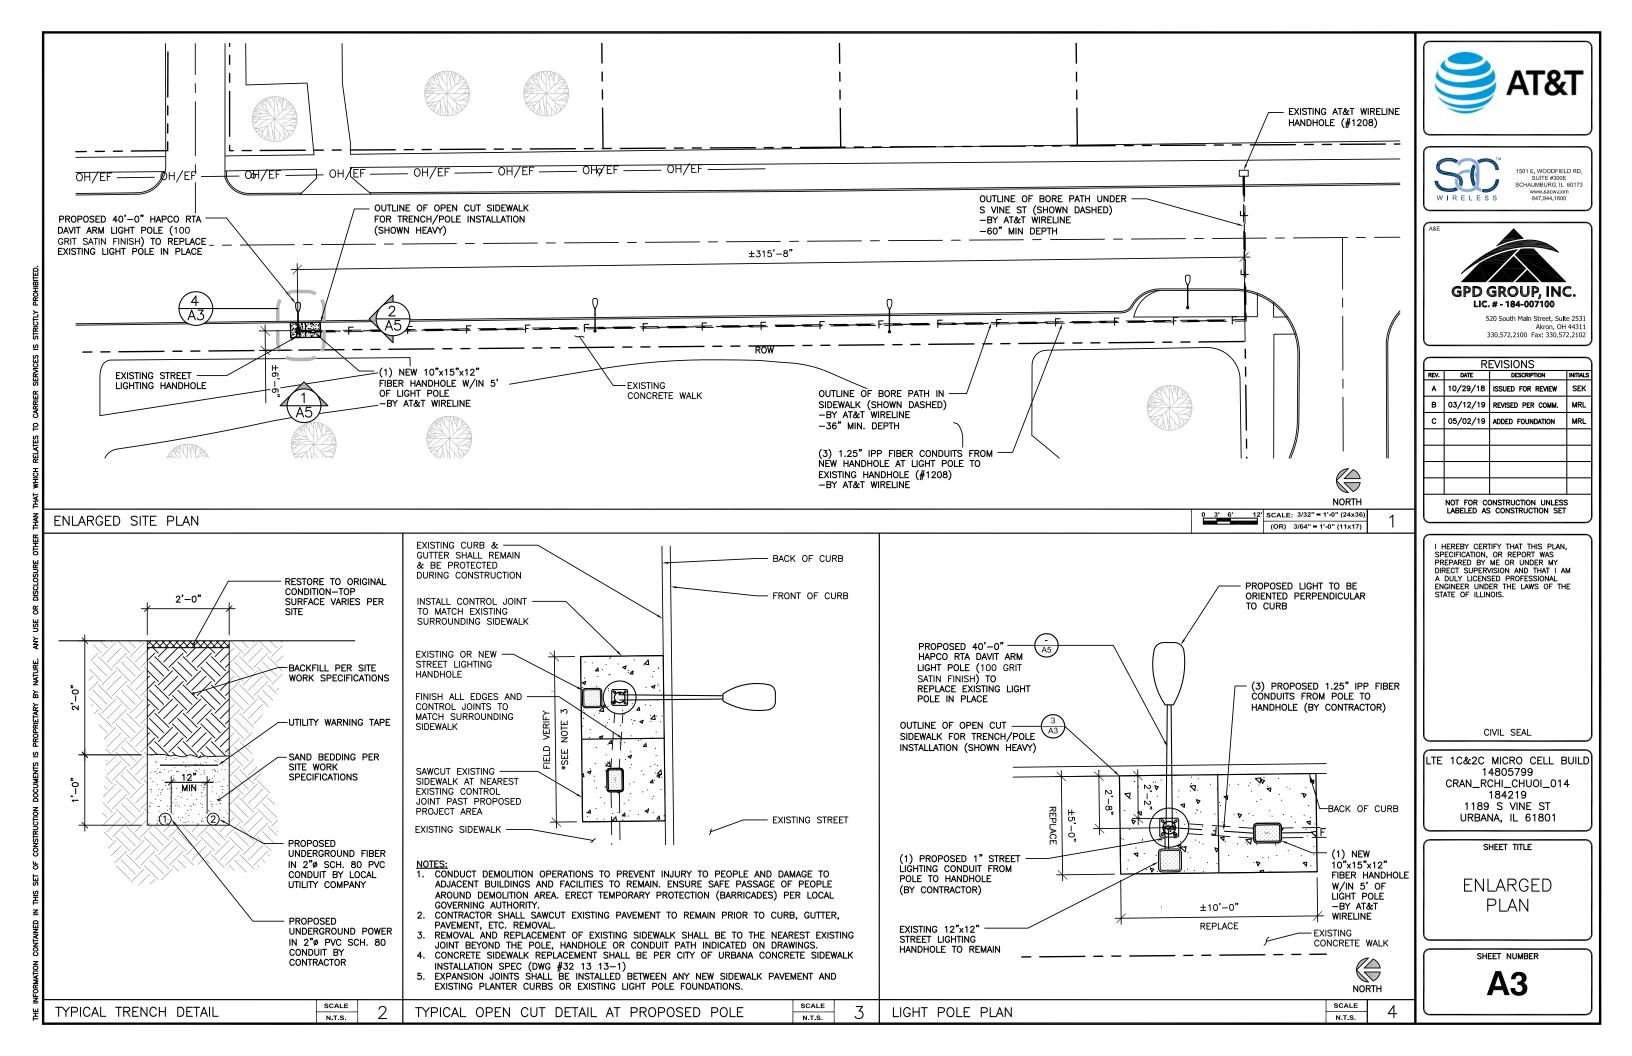







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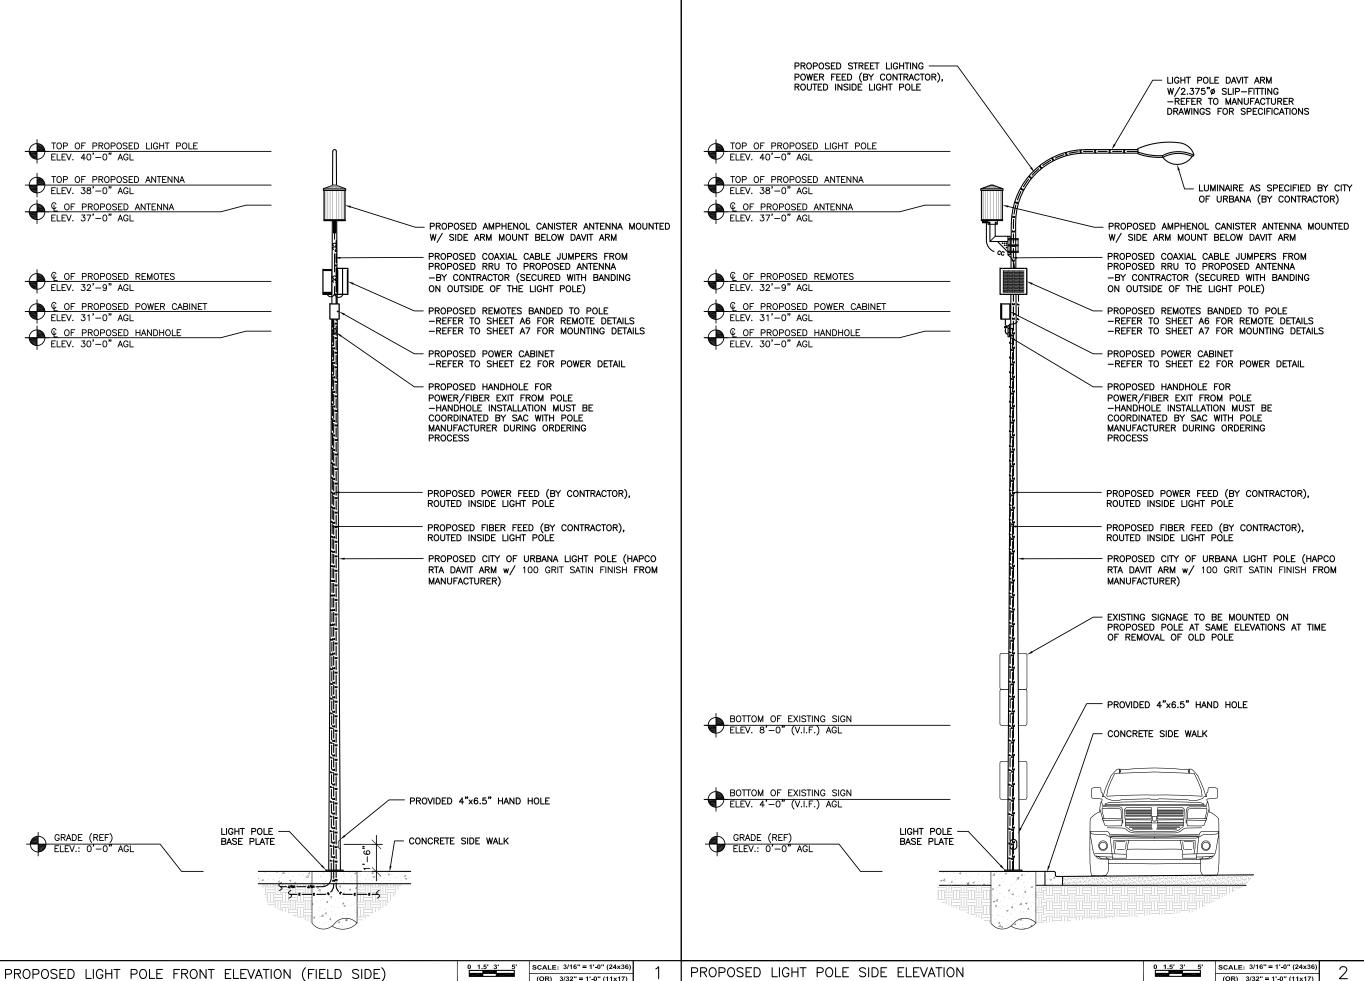
SHEET TITLE

EXISTING LIGHT POLE ELEVATION

SHEET NUMBER

A4

0 1' 2' 4' SCALE: 1/4" = 1'-0" (24x36)
(OR) 1/8" = 1'-0" (11x17)









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SHEET TITLE

PROPOSED LIGHT POLE **ELEVATIONS**

SHEET NUMBER

A5

PROPOSED LIGHT POLE SIDE ELEVATION

MANUFACTURER: MODEL: MECHANICAL SPECIFICATIONS: HEIGHT: WEIGHT:


ERICSSON RRUS 4415 B25

14.96 IN (380mm) 13.19 IN (335mm) 5.39 IN (137mm) 46 LBS (21kg)

INTERFACE SPECIFICATIONS: CPRI:

2x2.5/4.9/9.8/10.1 Gbps (ONLY USE ERICSSON SUPPLIED AND APPROVED SFPs) 2

EXTERNAL ALARMS:

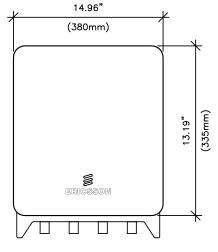



MANUFACTURER: MODEL: ERICSSON RRUS-11

MECHANICAL SPECIFICATIONS: HEIGHT: WIDTH: DEPTH: WEIGHT:


19.7 IN (500mm) 17.0 IN (431mm) 7.2 IN (182mm) 50.7 LBS (23kg)

-48 VDC OR 100-250 VAC

INTERFACE SPECIFICATIONS: ANTENNA PORTS: OPTICAL INDICATORS: EXTERNAL ALARMS: FIELD GROUND: 2x7/16 IEC-169-4

ELECTRICAL SPECIFICATIONS: POWER SUPPLY:

ENVIRONMENTAL SPECIFICATIONS: NORMAL OPERATING TEMP.: RELATIVE HUMIDITY: -40°C TO +55°C 5-100%

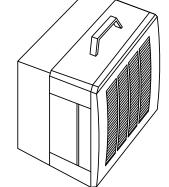





RRUS 4415 B25 DETAILS

SCALE N.T.S.

RRUS-11 DETAILS

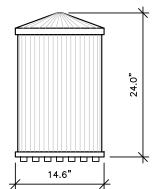



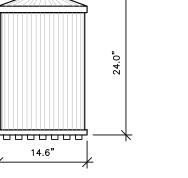



- ANTENNA DIMENSIONS (HEIGHT X DIAMETER):
 WEIGHT W/OUT MOUNTING BRACKET KIT:
 SURVIVAL WIND SPEED:
 WIND AREA:
 WIND LOAD (100 MPH):

24.0"x14.6" TBD LBS 150 MPH 2.4 FT² 43 LBF

14.6"

TOP VIEW







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SHEET TITLE

EQUIPMENT DETAILS

SHEET NUMBER

A6



DETAIL NOT USED


SCALE N.T.S.

ANTENNA DETAIL

SCALE: NTS


SCALE

N.T.S.

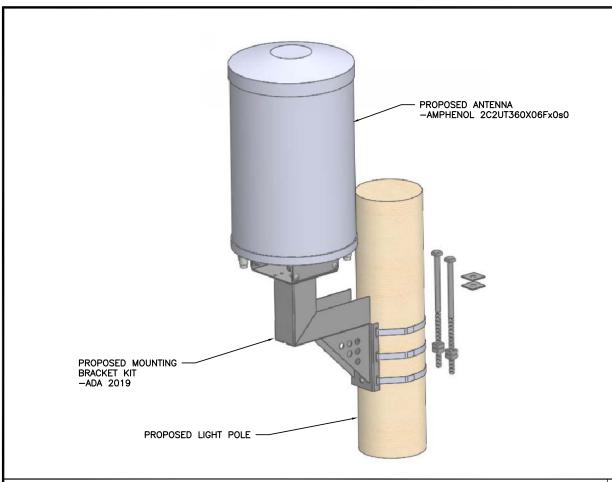

ANTENNA MOUNTING DETAIL

SCALE

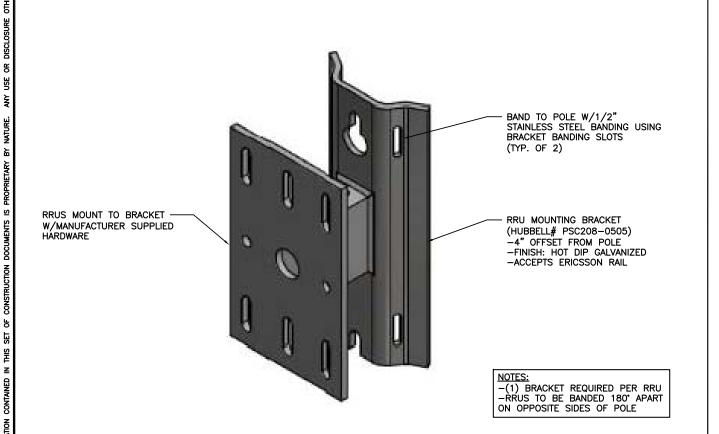

EXAMPLE CRAN RF CAUTION SIGN

A CAUTION AT&T operates antennas at this structure Above this point you are entering an area where radio frequency (RF) fields may exceed the FCC General Occupational Exposure limits. Follow safety guidelines for working in an RF environment Keep 1 ft. away from the fronts of

Contact AT&T at 800-638-2822, opt. 9, 3 and follow their instructions prior to performing any maintenance or repairs above this point.

Cell Site USID.

EXAMPLE CRAN RF NOTICE SIGN



Contact AT&T at 800-638-2822, opt. 9, 3 and follow their instructions prior to performing any maintenance or repairs above this point.

This is AT&T Site USID_

EXAMPLE CRAN POLE POWER DISCONNECT SIGN

DISCONNECT AC & DC POWER BOTH BEFORE WORKING ON POLE Contact AT&T at 800-638-2822, opt. 9, 3 and follow their

instructions prior to performing any maintenance or repairs above this point. Cell Site USID

EXAMPLE STONEHOUSE RD899 RF NOTICE SIGN

NOTICE

RF energy emitted by this antenna may exceed the FCC's exposure limits for the general population.

Stay at least 1 feet away from the antenna.

Call AT&T at 800-638-2822, option 9 then 3, for help if you need access within 3 feet. STONEHOUSE RD899

CRAN Pole Power Disconnect, RF Notice, and Caution signs shall be ordered through Stonehouse Signs. Three versions are available for each of the signs shown in Figures 16, 17, and 18: .055 Polyethylene – Reflective, .025 Aluminum – Reflective, and Peel Back Label – Reflective. All versions are 6°x6" with font designed to be visible from 2-3 feet away when approached from below to provide warning about ascending into the high RF exposure areas. The RF Caution sign shown in Figure 19 is designed to be visible from 3 feet away and is available in the reflective peel back label version only. It is designed to fit on most of the CRAN/Small Cell antenna types currently deployed. It may also be placed on antenna shrouds as shown in Figures 11 and 12.

SIGNAGE NOTE:
SIGNAGE SHALL BE INSTALLED PER AT&T DIRECTION





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05/02/19	ADDED FOUNDATION	MRL								
	DATE 10/29/18 03/12/19	10/29/18 ISSUED FOR REVIEW 03/12/19 REVISED PER COMM.								

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SHEET TITLE

MOUNTING DETAILS


SHEET NUMBER

A7

SCALE RRU MOUNTING DETAIL AT&T SIGNAGE DETAIL N.T.S.

SCALE: NTS

16.5 pt.

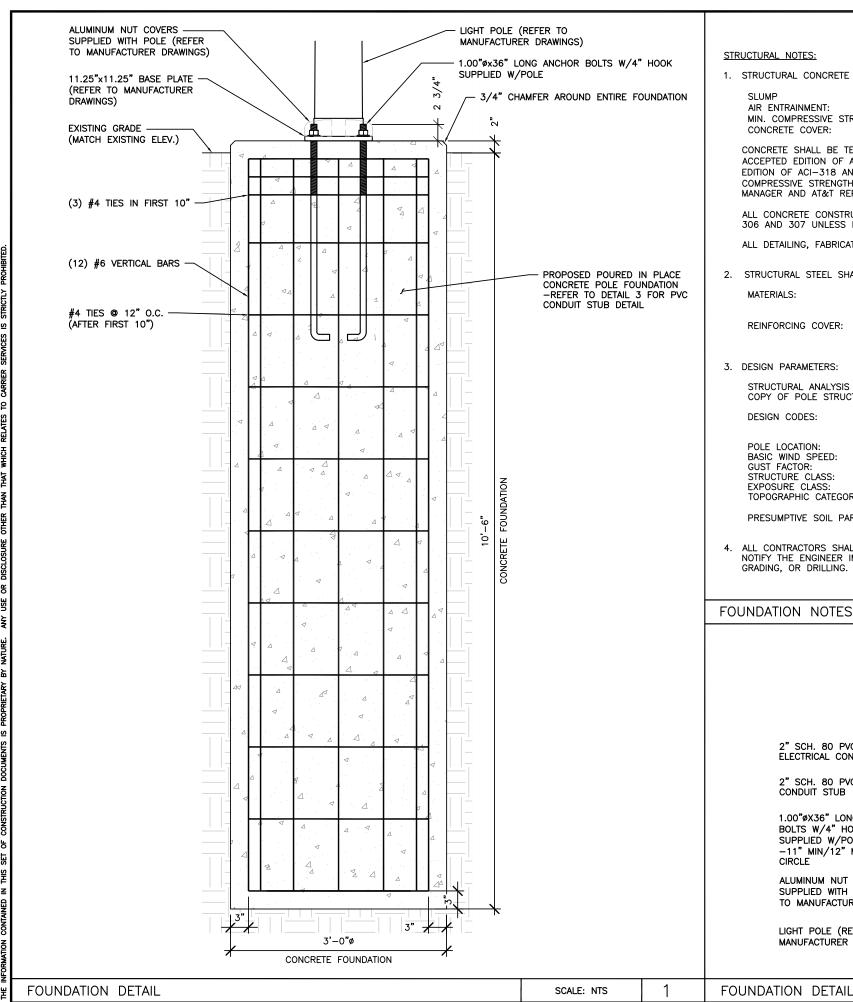

STRUCTURAL NOTES:

1. STRUCTURAL CONCRETE SHALL MEET THE FOLLOWING SPECIFICATIONS:

 $4" (\pm 1")$ AIR ENTRAINMENT: 6% (±1%) MIN. COMPRESSIVE STRENGTH (F'c): 4,500 PSI @ 28 DAYS CONCRETE COVER: 3" ALL SIDES

CONCRETE SHALL BE TESTED BY A REPUTABLE INDEPENDENT THIRD PARTY TESTING AGENCY IN ACCORDANCE WITH LATEST WISCONSIN ACCEPTED EDITION OF ACI-318. FIVE (5) CONCRETE CYLINDERS SHALL BE CAST IN ACCORDANCE WITH LATEST WISCONSIN ACCEPTED EDITION OF ACI-318 AND BE LABORATORY CURED. THE AVERAGE OF THREE (3) CONCRETE CYLINDERS SHALL HAVE A MINIMUM COMPRESSIVE STRENGTH (F'c) OF 4,500 PSI AT 28 DAYS. THE TESTING RESULTS SHALL BE PROVIDED TO THE CONSTRUCTION MANAGER AND AT&T REPRESENTATIVE.

ALL CONCRETE CONSTRUCTION SHALL CONFORM TO ACI*96, "STANDARD SPECIFICATION FOR STRUCTURAL CONCRETE" AND ACI 305, 306 AND 307 UNLESS NOTED OTHERWISE.

ALL DETAILING, FABRICATION AND PLACING OF CONCRETE SHALL CONFORM TO ACI 318-11.

2. STRUCTURAL STEEL SHALL MEET THE FOLLOWING SPECIFICATIONS:

REINFORCING ASTM 615, GRADE 60 MATERIALS: ANCHOR BOLTS ASTM F1554, GRADE 55

REINFORCING COVER: TOP воттом 3"

3. DESIGN PARAMETERS:

STRUCTURAL ANALYSIS OF THE POLE AND FOUNDATION WAS COMPLETED BY OTHERS. COORDINATE WITH SAC WIRELESS FOR A COPY OF POLE STRUCTURAL ANALYSIS.

DESIGN CODES: 2015 INTERNATIONAL BUILDING BUILDING CODE

TIA-222-G

POLE LOCATION: CHAMPAIGN COUNTY, IL

BASIC WIND SPEED: GUST FACTOR: 130 MPH 1.14 STRUCTURE CLASS: CLASS II

EXPOSURE CLASS: TOPOGRAPHIC CATEGORY:

MANUFACTURER DRAWINGS)

PRESUMPTIVE SOIL PARAMETERS: FOUNDATION IS BASED ON AN ALLOWABLE LATERAL BEARING PRESSURE OF AT LEAST 200 PSF/FT.

4. ALL CONTRACTORS SHALL EXERCISE GREAT CARE DURING EXCAVATION. CONTRACTOR SHALL PREDETERMINE UTILITY LOCATIONS AND NOTIFY THE ENGINEER IMMEDIATELY IF DEVIATION FROM PLANS EXIST. CONTRACTOR SHALL CONTACT 811 48 HR. PRIOR TO DIGGING, GRADING, OR DRILLING.

FOUNDATION NOTES

3'-0"ø REINFORCED CONCRETE FOUNDATION 2" SCH. 80 PVC LIGHTING 2" SCH. 80 PVC FIBER ELECTRICAL CONDUIT STUB CONDUIT STUB 2" SCH. 80 PVC ELECTRIC CONDUIT STUB 1.00"øX36" LONG ANCHOR BOLTS W/4" HOOK 1/2" SCH. 80 PVC SUPPLIED W/POLE GROUNDING CONDUIT STUB -11" MIN/12" MAX BOLT CIRCLE ALUMINUM NUT COVERS -SUPPLIED WITH POLE (REFER 11.25"X11.25" BASE PLATE TO MANUFACTURER DRAWINGS) (REFER TO MANUFACTURER DRAWINGS) LIGHT POLE (REFER TO





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SCALE

N.T.S.

2

3

SCALE: NTS

STRUCTURAL SEAL


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SHEET TITLE

POLE **FOUNDATION** DETAILS

SHEET NUMBER

S1

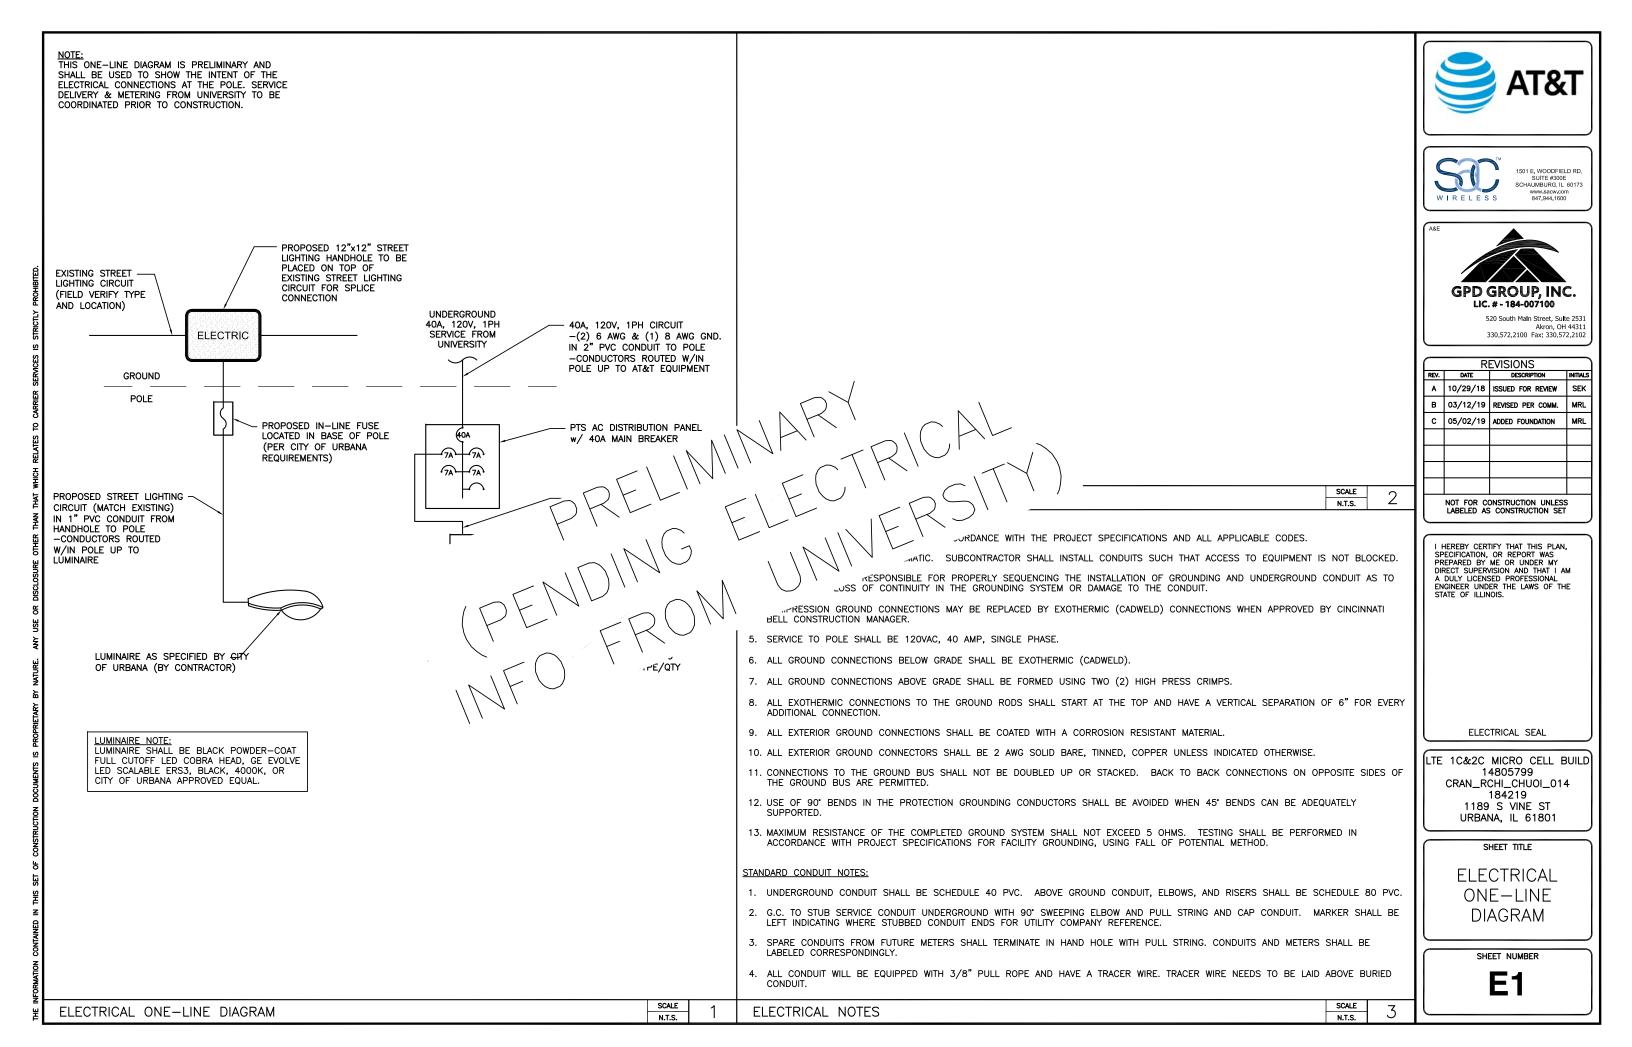

		AC	POW	ER PAN	NEL (RAY	CAP RS	SCAC-65	533-P-	120-	D)	
				20 VOL	TS, 1-PH	ASE, 2-	WIRE,	40A		•	
	N	1AIN	RATIN	IG (A):	4	0	SYSTE	M VO	LTA	GE (V):	120
DESCRIPTION	VA	c/nc	BKR	POSN	L1	L2	POSN	BKR	c/nc	VA	DESCRIPTION
RRUS-11	520	С	7	1	520		2	7	С	0	SPARE
RRUS-4415	670	С	7	3		670	4	7	С	0	SPARE
SPARE	0		7	5	0						
	PHAS	ETC	TALS	(VA):	520	670					
Cl	JRRENT	PEF	R PHA	SE (A):	5	7	7 Amperes/phase cannot exceed main breaker rating				
	PAN	EL.	TOTAL	(VA):	11	190 Legend: c = continuous, nc = non-continuous				ous, nc = non-continuous	
	PANEL			. ,		CC	NNECT	ED LC	AD	(kVA):	1.2
PANEL LOADING (10	00% non-	-conf	. load	(kVA):	0.0						
PANEL LOADING (125	% contin	านอน	s load	(kVA):	1.5						
PANEL	LOADIN	IG (T	OTAL	(kVA):	1.5						
	SPARE	CAP	ACITY	(kVA):	3.3						

MANUFACTURER: MODEL: PTS PTS90120

MECHANICAL SPECIFICATIONS: HEIGHT: WIDTH: DEPTH: WEIGHT: 10.13 IN 06.15 IN 06.00 IN 10 LBS

ELECTRICAL SPECIFICATIONS: AMPERAGE: OPERATING VOLTAGE: QTY OF PROTECTED CIRCUITS:

ENVIRONMENT SPECIFICATIONS: NORMAL OPERATING TEMP.: -40°C TO +60°C







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ELECTRICAL SEAL

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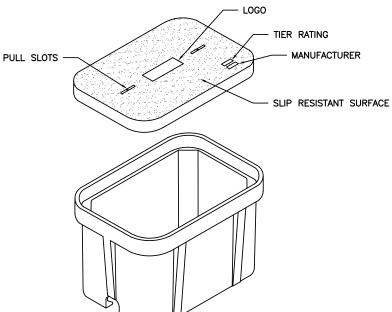
SHEET TITLE

PANEL SCHEDULE & ELECTRICAL **DETAILS**

SHEET NUMBER

E2


SCALE SCALE ELECTRICAL PANEL SCHEDULE RAYCAP AC DISCONNECT DETAIL N.T.S.



NOTES:

- CONTRACTOR SHALL SUPPLY & INSTALL UL LISTED, TIER 22 RATED, 24"x36" PG STYLE GASKETED POLYMER CONCRETE HANDHOLE (QUAZITE PG2436BA36 OR APPROVED EQUAL) W/UL LISTED, TIER 22 24"x36" PG STYLE POLYMER CONCRETE COVER (QUAZITE PG2436HH21 OR APPROVED EQUAL). COVER SHALL BEAR THE LOGO "FIBER OPTICS" AND TIER RATING.
- 2. HANDHOLE SHALL BEAR ON A MIN. 6" COMPACTED CLEAN GRAVEL BASE.
- 3. CONDUITS STUBBED UP INSIDE BOTTOM OF HANDHOLE SHALL EXTEND A MINIMUM OF 4" ABOVE GRAVEL BASE.

SCALE SCALE FIBER HAND HOLE DETAIL DETAIL NOT USED N.T.S.

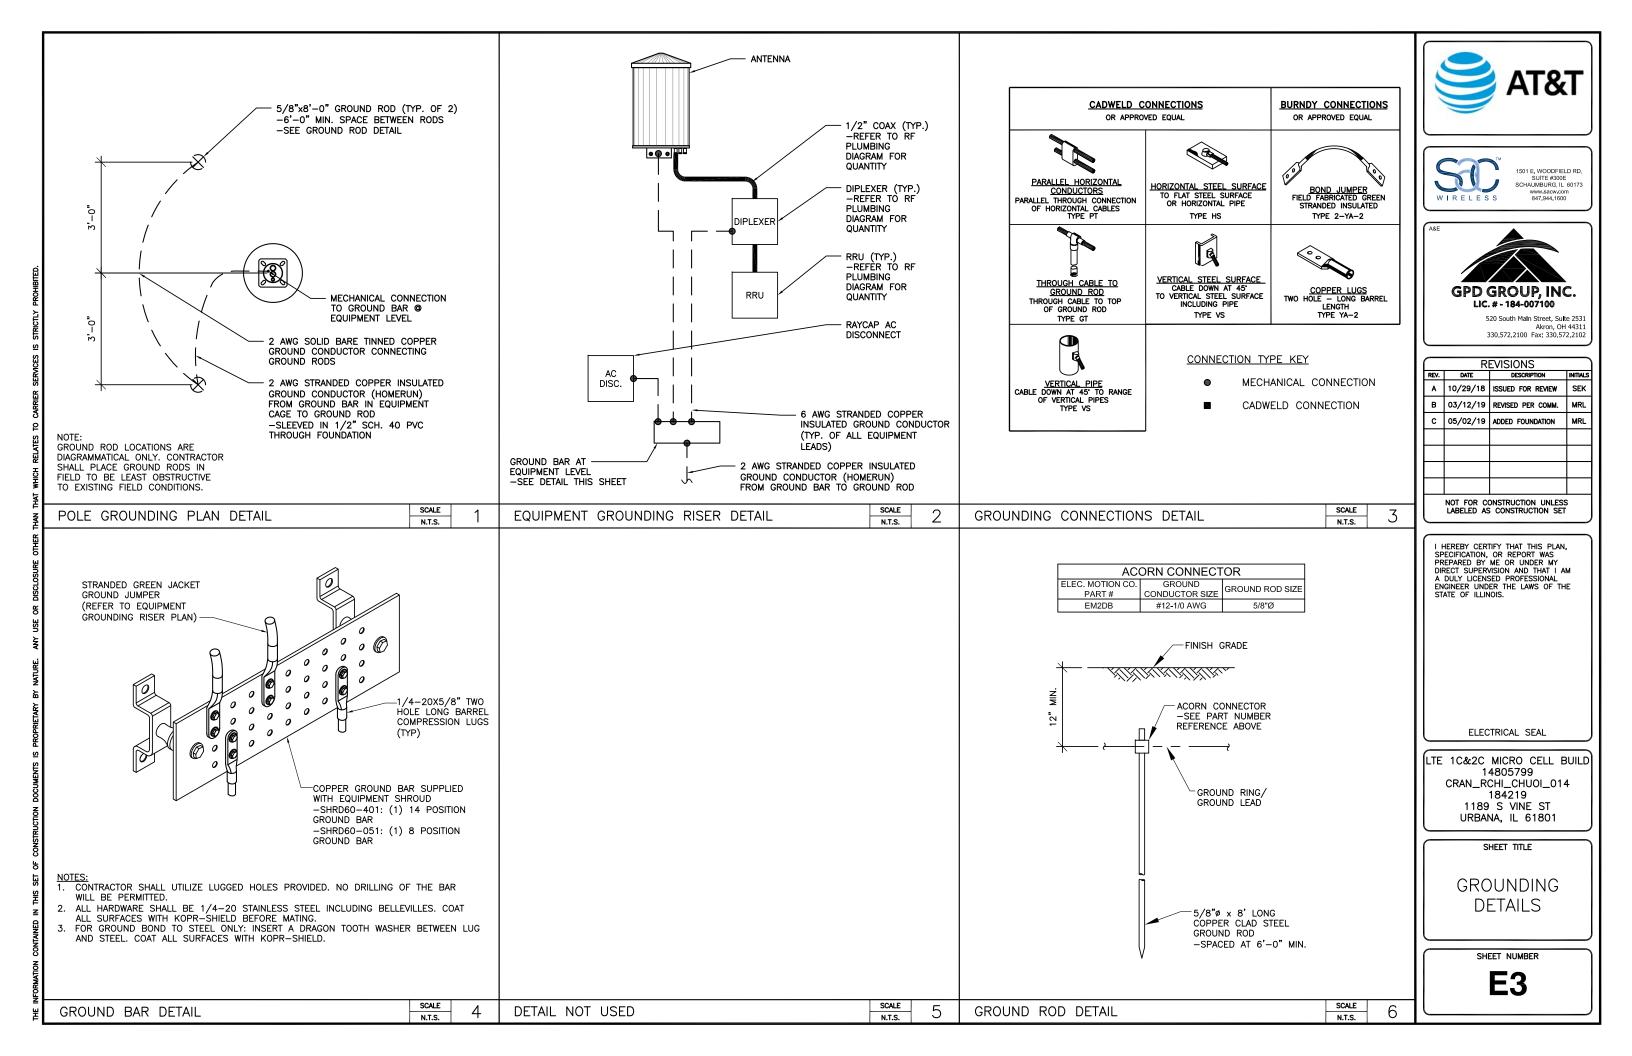


C. C.													
Configuration Name				850 MHz 4T4R LTE				The second second second		3.5 GHz LAA LTE		THE PARTY NAMED IN	
Micro #17	X	NΔ	NΔ	NΔ	NΔ	X	NΔ	NΔ	NΔ	NΔ	1	2	14 Ports Antenna





Important Note:

For detailed radio to antenna wiring refer to the latest 4T4R Antenna/Radio Port Connection Field Notice (RF-HW-2016-234) and the 4T Wiring Playbook

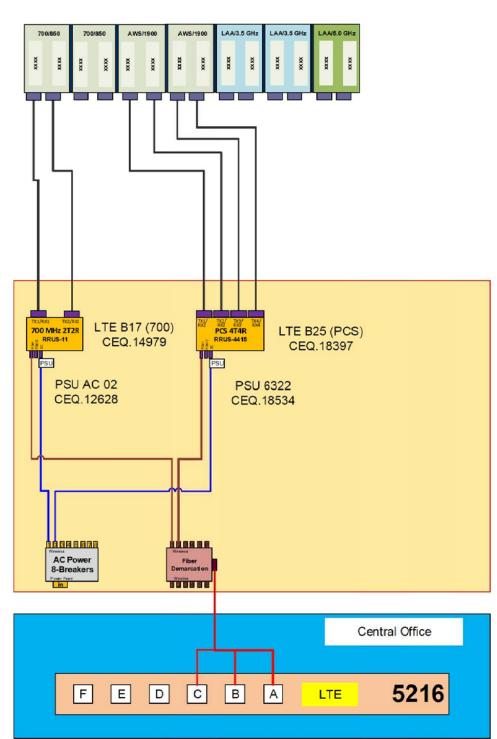





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REV.	DATE	DESCRIPTION	INITIALS							
A	10/29/18	ISSUED FOR REVIEW	SEK							
В	03/12/19	REVISED PER COMM.	MRL							
С	05/02/19	ADDED FOUNDATION	MRL							
	-									

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REFERENCE ONLY

LTE 1C&2C MICRO CELL BUILD 14805799 CRAN_RCHI_CHUOI_014 184219 1189 S VINE ST URBANA, IL 61801

SHEET TITLE


RF PLUMBING DIAGRAM

SHEET NUMBER

RF1

RF PLUMBING DIAGRAM

SCALE N.T.S.

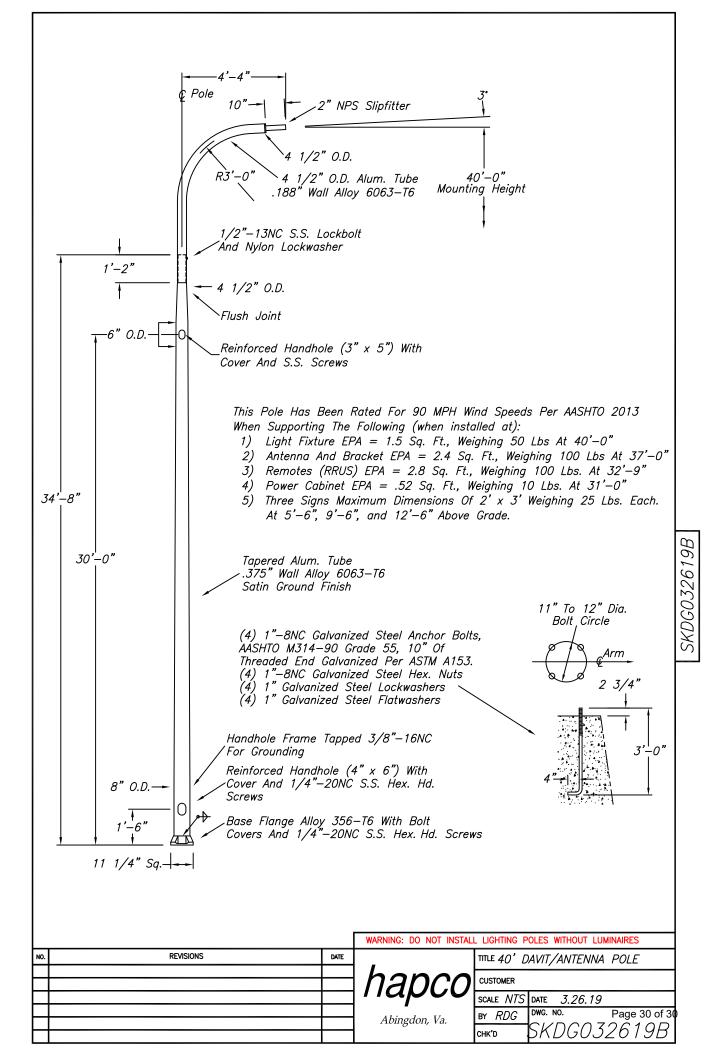

PROJECT INFORMATION

SITE NAME: COUNTY: ADDRESS:

CRAN_RCHI_CHUOI_026 CHAMPAIGN 784 S LINCOLN AVE CHAMPAIGN, IL 61801 CITY OF URBANA

FA NUMBER:

14805853 3304A0AAQN / 3304A0AARJ MRCHI025454 / MRCHI025479

LATITUDE: LONGITUDE: **ELEVATION:**

40° 06' 22.82" (40.106339°) 88° 13' 09.21" (-88.219225°)

LIGHT POLE/UTILITY POLE OWNÉR:

CITY OF URBANA

APPLICANT:

AT&T MOBILITY 930 NATIONAL PARKWAY SCHAUMBURG IL 60173

AT&T_PROJECT

MANAGER/SITE ACQUISITION:

VANESSA ROSS (217) 814-2314 VF2021@ATT.COM

AT&T CONSTRUCTION

MANAGER:

CHRISTIANA RACHAL CR630A@ATT.COM

PROJECT CONSULTANTS

PROJECT MANAGER: SAC WIRELESS LLC

> 540 W. MADISON ST. (9TH FLOOR) CHICAGO IL 60661 CONTACT: PRITI MORE PHONE: (312) 789-4353 EMAIL: PRITI.MORE@SACW.COM

ARCHITECT:

GPD GROUP, INC. — 184—007100 520 S. MAIN ST., SUITE 2531 AKRON, OH 44311

JAMES HOM

SAC C.M. MARK KLEPACKI

EMAIL: MARK.KLEPACKI@SACW.COM

SAC P.M.

EMAIL: JAMES.HOM@SACW.COM

AT&T MOBILITY

PROJECT: LTE 1C&2C PICO CELL BUILD

SITE #: CRAN_RCHI_CHUOI_026


USID / NODE: 184230 FA #: 14805853

PTN #: 3304A0AAQN / 3304A0AARJ PACE #: MRCHI025454 / MRCHI025479

ENODEB NAME: ILL07050F R02 JURISDICTION: CITY OF URBANA

SITE NAME: CRAN RCHI CHUOI 026 **ADDRESS:**

784 S LINCOLN AVE **CHAMPAIGN, IL 61801**

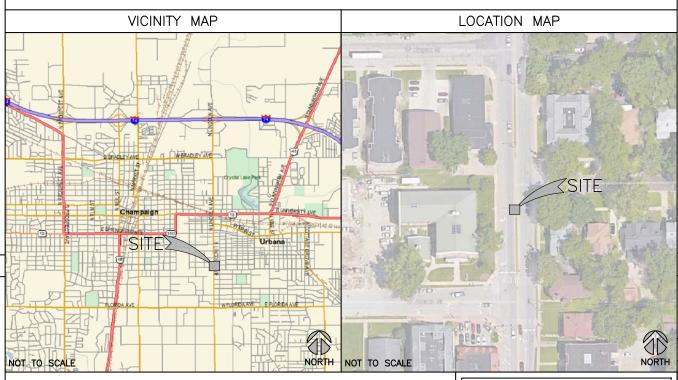



Know what's below. now what's below.

Call before you dig.

REQUIRES MIN OF 2
WORKING DAYS NOTICE
BEFORE YOU EXCAVATION

	DRAWING INDEX
T1	TITLE SHEET
A1	FIBER DELIVERY PLANS (REFERENCE ONLY)
A2	OVERALL SITE PLAN
A3	ENLARGED PLAN
A4	EXISTING LIGHT POLE ELEVATION
A5	PROPOSED LIGHT POLE ELEVATIONS
A6	EQUIPMENT SHROUD DETAILS (REFERENCE ONLY)
A7	EQUIPMENT DETAILS (REFERENCE ONLY)
A8	MOUNTING DETAILS
S1	POLE FOUNDATION DETAILS
E1	ELECTRICAL ONE-LINE DIAGRAM
E2	PANEL SCHEDULE & ELECTRICAL DETAILS
E3	GROUNDING DETAILS
RF1	RF PLUMBING DIAGRAM (REFERENCE ONLY)
REF	POLE MANUFACTURER DESIGN (BY OTHERS)

SCOPE OF WORK

THIS IS NOT AN ALL INCLUSIVE LIST. CONTRACTOR SHALL UTILIZE SPECIFIED EQUIPMENT PART OR ENGINEER APPROVED EQUIVALENT. CONTRACTOR SHALL VERIFY ALL NEEDED EQUIPMENT TO PROVIDE A FUNCTIONAL SITE. THE PROJECT GENERALLY CONSISTS OF THE FOLLOWING:

- REMOVE EXISTING LIGHT POLE AND REPLACE WITH NEW 30' HAPCO DOUBLE DAVIT ARM (RTA30E8C4D2601) LIGHT POLE (100 GRIT SATIN FINISH)
- INSTALL NEW ELECTRIC SERVICE RUN FROM EXISTING SOURCE TO NEW LIGHT POLE. METER SUPPLIED & INSTALLED BY CONTRACTOR.
 INSTALL NEW FIBER SERVICE RUN FROM EXISTING SOURCE TO NEW LIGHT
- POLE LOCATION AS SHOWN.
- INSTALL NEW POWER & FIBER EQUIPMENT PER PLAN
- INSTALL (1) NEW OMNI ANTENNA
- INSTALL (2) PCS 2203 RRUS & (1) LAA 2205 RRU IN CHARLES DENSIFICATION SHROUD
- INSTALL CABLING AS REQUIRED
- GROUND AS REQUIRED
- LIGHT POLE LUMINARY TO BE SUPPLIED & INSTALLED BY CONTRACTOR. LUMINARY MUST BE APPROVED BY CITY OF URBANA PRIOR TO ORDER. STREET LIGHTING HANDHOLE (IF REQUIRED) SUPPLIED & INSTALLED BY
- POTHOLING SHALL BE REQUIRED FOR ANY PROPOSED UTILITY CROSSING
- HYDROVAC SHALL BE USED FOR ALL TRENCHING & POTHOLING ACTIVITIES CONTRACTOR SHALL MAINTAIN INTEGRITY OF EXISTING POLE DURING REMOVAL & COORDINATE RETURN OF REMOVED POLE TO THE CITY OF URBANA

UTILITY DELIVERY METHOD TO PROPOSED POLE - FIBER - UNDERGROUND

- POWER UNDERGROUND

CODE COMPLIANCE

- 2015 INTERNATIONAL BUILDING CODE W/CITY AMMENDMENTS
- 2014 NATIONAL ELECTRIC CODE W/CITY AMMENDMENTS

SPECIAL NOTES

- ALL WORK SHALL BE INSTALLED IN CONFORMANCE WITH CURRENT AT&T CONSTRUCTION INSTALLATION GUIDE.
- EXISTING CONDITIONS WILL BE CHANGED & VERIFIED IN FIELD. IF SIGNIFICANT DEVIATIONS OR DETERIORATION ARE ENCOUNTERED AT THE TIME OF CONSTRUCTION, A REPAIR PERMIT WILL BE OBTAINED & CONTRACTOR SHALL NOTIFY ENGINEER IMMEDIATELY.
- THESE DRAWINGS ARE FULL SIZE & SCALEABLE ON 11"X17" SHEET SIZE. STATEMENT THAT COMPLIANCE WITH THE ENERGY CODE IS NOT REQUIRED. -SCOPE OF WORK DOES NOT INVOLVE MODIFICATIONS TO EXTERIOR ENVELOPE OF BUILDING, HVAC SYSTEMS OR ELECTRICAL LIGHTING

DO NOT SCALE DRAWINGS

CONTRACTOR SHALL VERIFY ALL PLANS & EXISTING DIMENSIONS & CONDITIONS ON THE JOB SITE & SHALL IMMEDIATELY NOTIFY THE ARCHITECT OR ENGINEER IN WRITING OF ANY DISCREPANCIES BEFORE PROCEEDING WITH THE WORK OR BE RESPONSIBLE FOR SAME.





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\cap	REVISIONS								
REV.	DATE	DESCRIPTION	INITIALS						
Α	10/31/18	ISSUED FOR REVIEW	SEK						
В	03/12/19	REVISED PER COMM.	MRL						
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HEREBY CERTIFY THAT THIS PLAN, HERBI CERTIFI THAI HIS FLAN, SPECIFICATION, OR REPORT WAS SPEPARED BY ME OR UNDER MY DIRECT SUPERVISION AND THAT I AM A DULY LICENSED PROFESSIONAL ENGINEER UNDER THE LAWS OF THE

CIVIL SEAL


LTE 1C&2C PICO CELL BUILD 14805853 CRAN_RCHI_CHUOI_026 184230 784 S LINCOLN AVE CHAMPAIGN, IL 61801


SHEET TITLE

TITLE SHEET

SHEET NUMBER

SAC File: T:\ATandT\184230\01 2017732 68 SAC\AE\CD\184230_CRAN_RCHI_CHUOI_026_CD.dwg 05/02/19 11:57

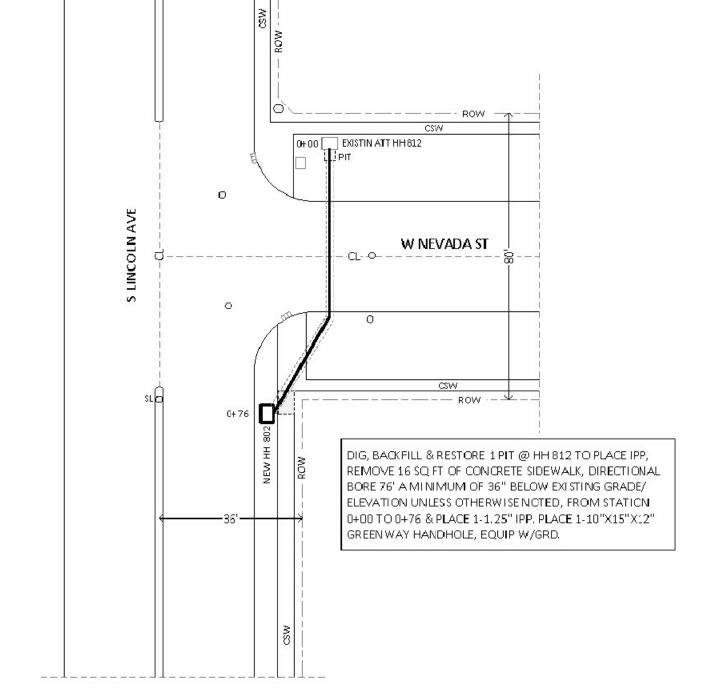

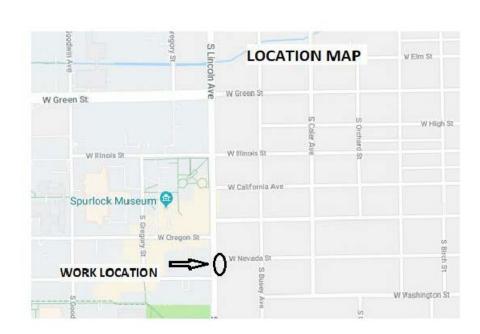



City of Urbana
Permit Sketch
County: Champaign
Twp: Cunningham
Qtr Sec: 17
Ref # A01CQ2N
Sheet 1 of 1





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REFERENCE ONLY

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14805853
CRAN_RCHI_CHUOI_026
184230
784 S LINCOLN AVE
CHAMPAIGN, IL 61801

SHEET TITLE

FIBER DELIVERY PLANS


SHEET NUMBER

A1

FIBER DELIVERY PLANS (PROVIDED BY AT&T)

SCALE N.T.S.

-

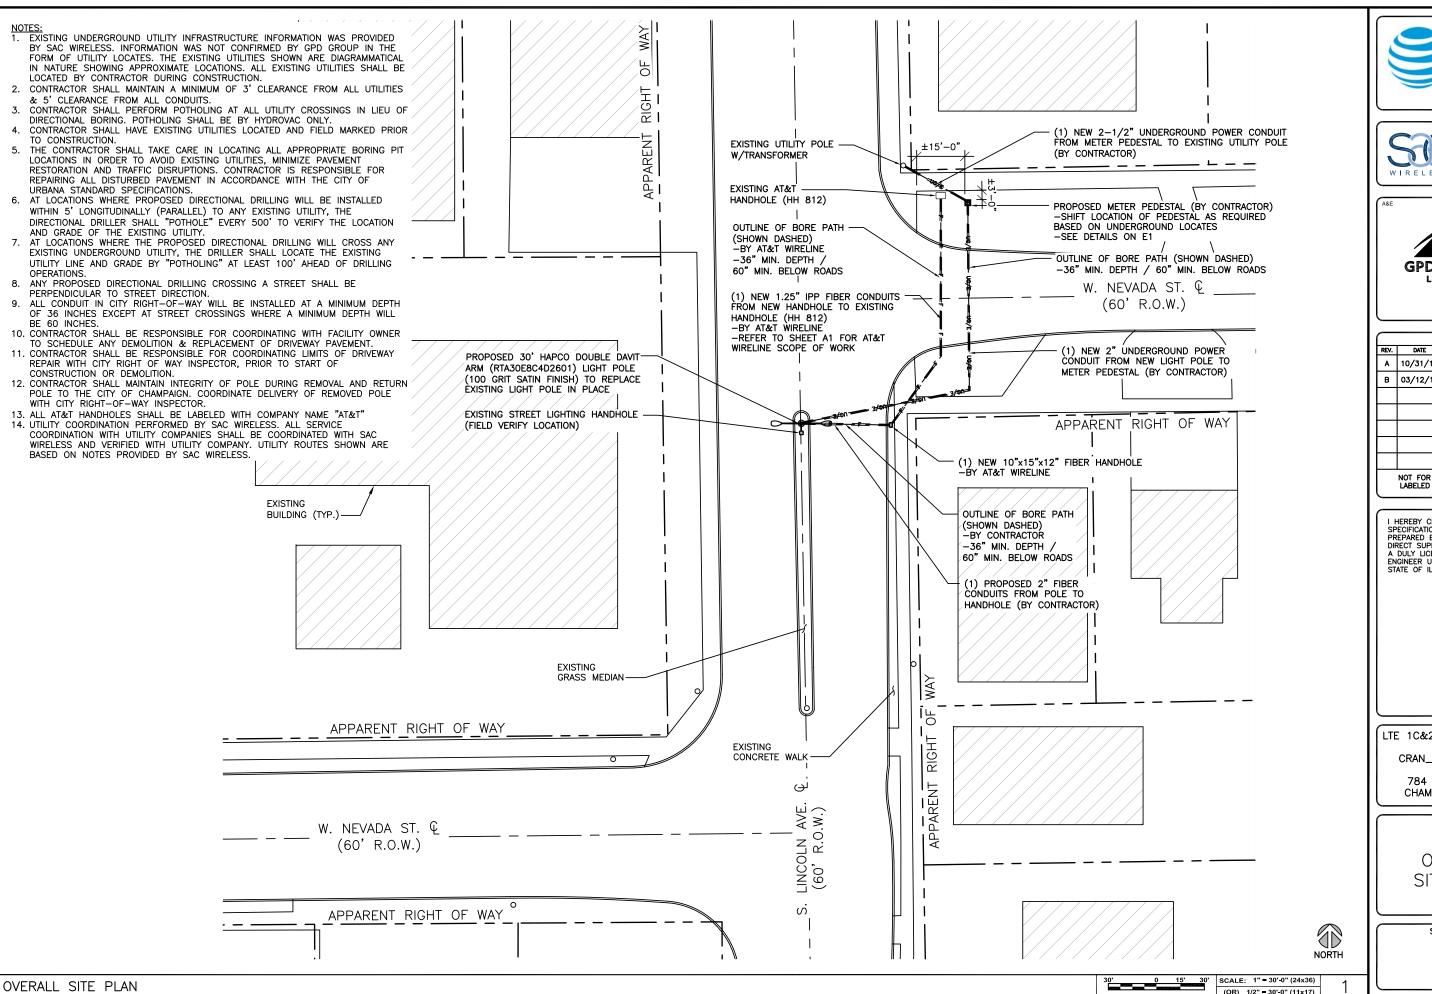





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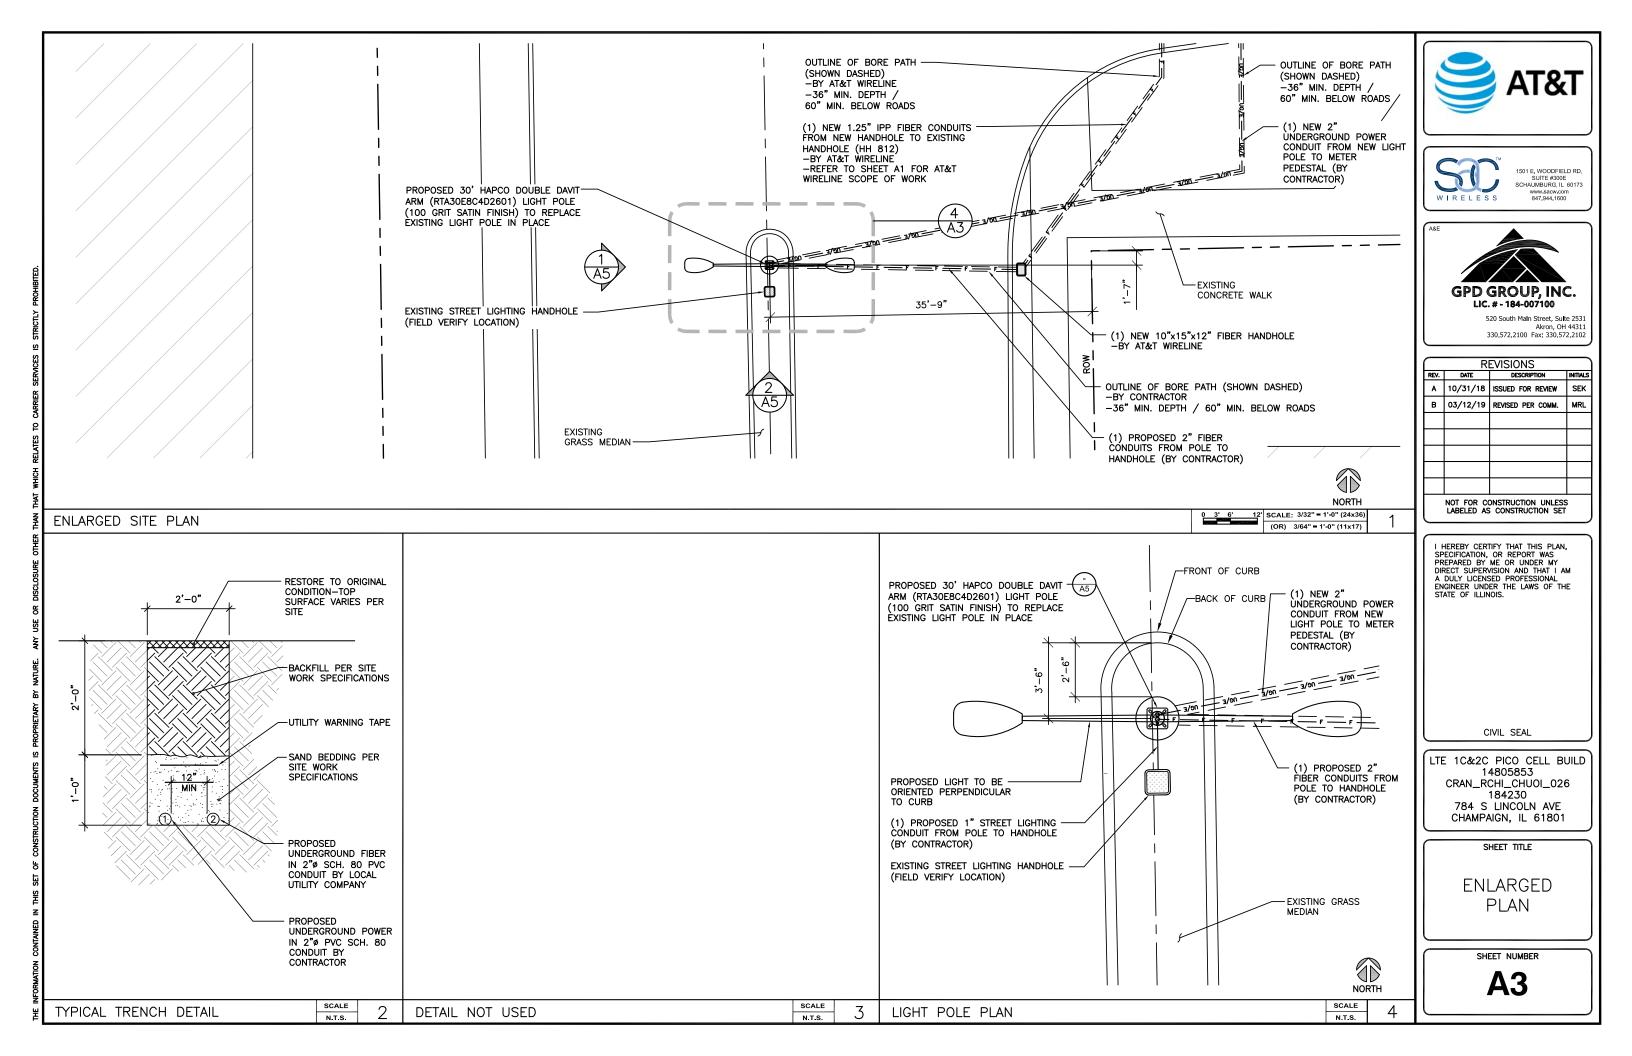
CIVIL SEAL

LTE 1C&2C PICO CELL BUILD 14805853 CRAN_RCHI_CHUOI_026 184230 784 S LINCOLN AVE CHAMPAIGN, IL 61801

SHEET TITLE

OVERALL SITE PLAN

SHEET NUMBER







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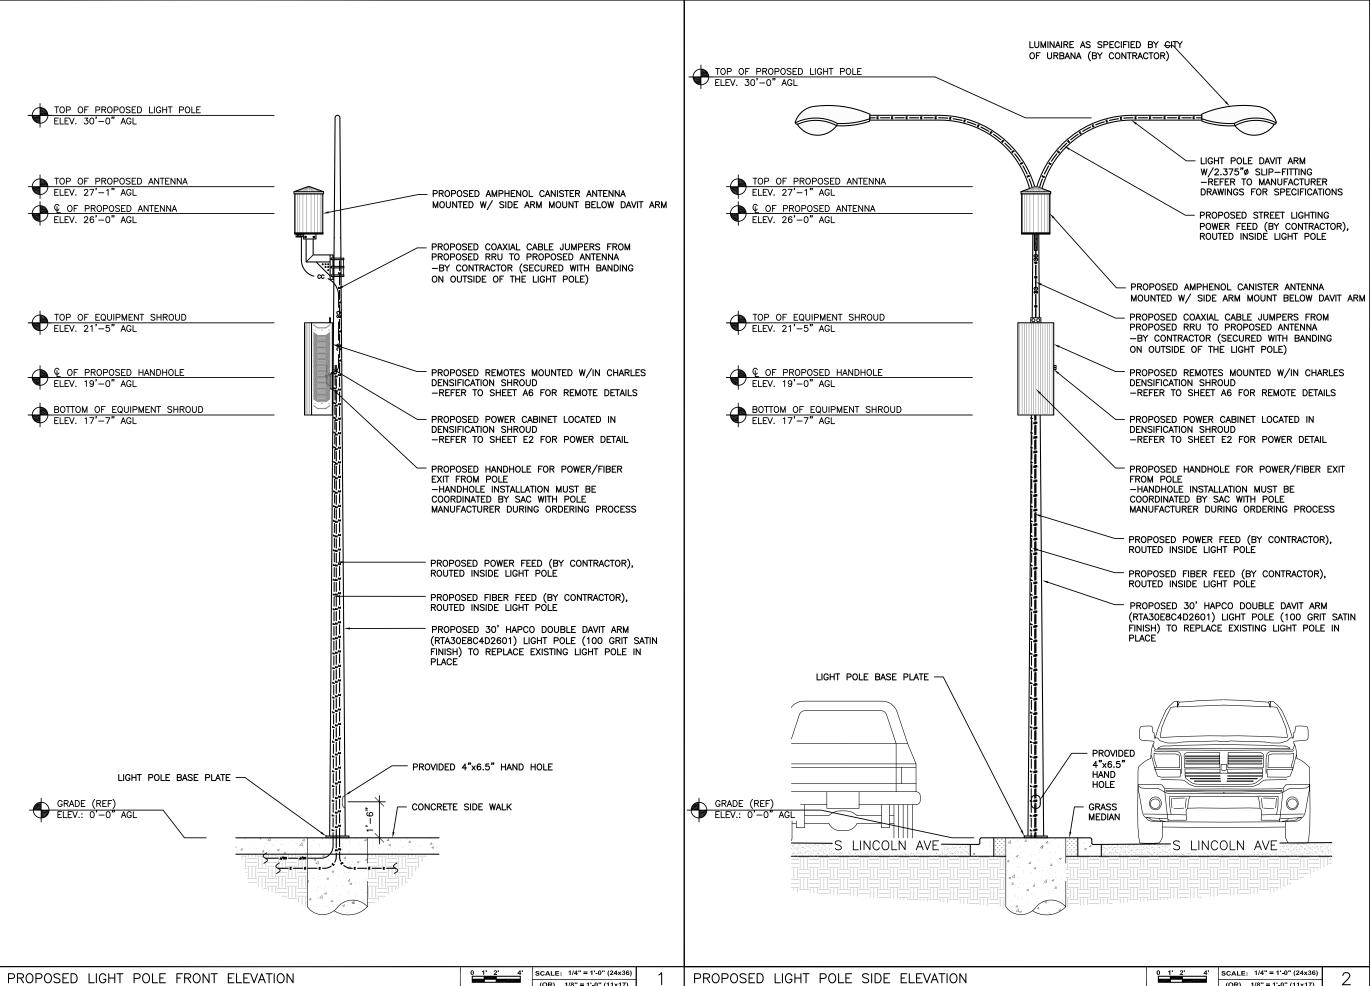
SHEET TITLE

EXISTING LIGHT POLE ELEVATION

SHEET NUMBER

A4

0 1' 2' 4' SCALE: 1/4" = 1'-0" (24x36)
(OR) 1/8" = 1'-0" (11x17)







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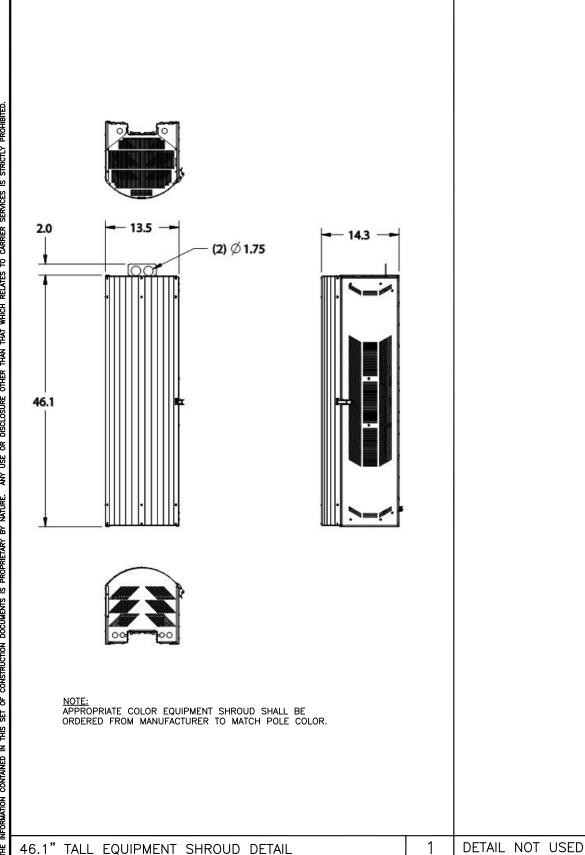
CIVIL SEAL

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SHEET TITLE

PROPOSED LIGHT POLE **ELEVATIONS**

SHEET NUMBER







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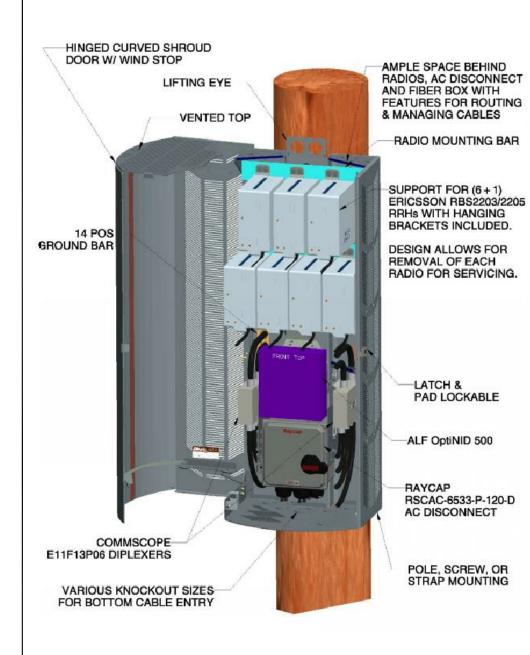
LTE 1C&2C PICO CELL BUILD 14805853 CRAN_RCHI_CHUOI_026 184230 784 S LINCOLN AVE CHAMPAIGN, IL 61801


SHEET TITLE

EQUIPMENT SHROUD DETAILS

SHEET NUMBER

3



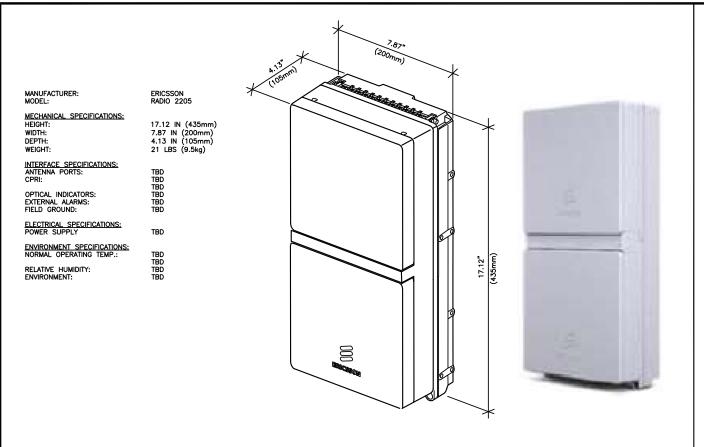

RRU 2205 DETAIL

DETAIL NOT USED

SCALE


N.T.S.

SCALE

N.T.S.

RRU 2203 DETAIL

ANTENNA DETAIL

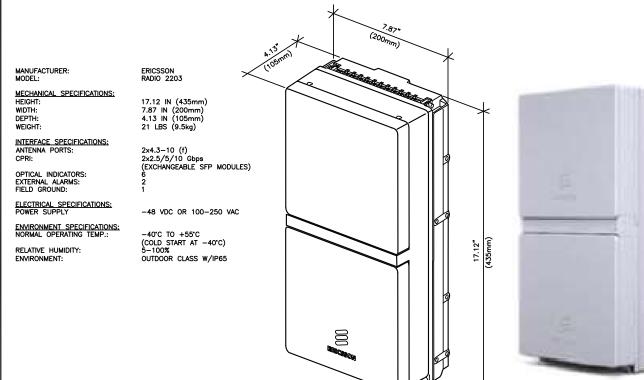





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SCALE

N.T.S.

SCALE: NTS

4

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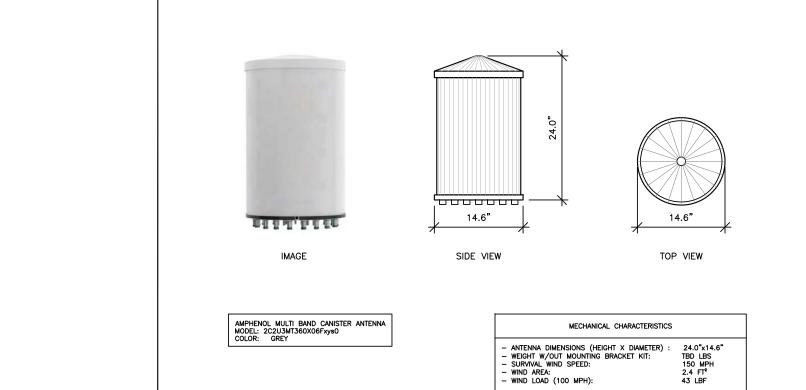
REFERENCE ONLY


LTE 1C&2C PICO CELL BUILD 14805853 CRAN_RCHI_CHUOI_026 184230 784 S LINCOLN AVE CHAMPAIGN, IL 61801

SHEET TITLE


EQUIPMENT DETAILS

SHEET NUMBER



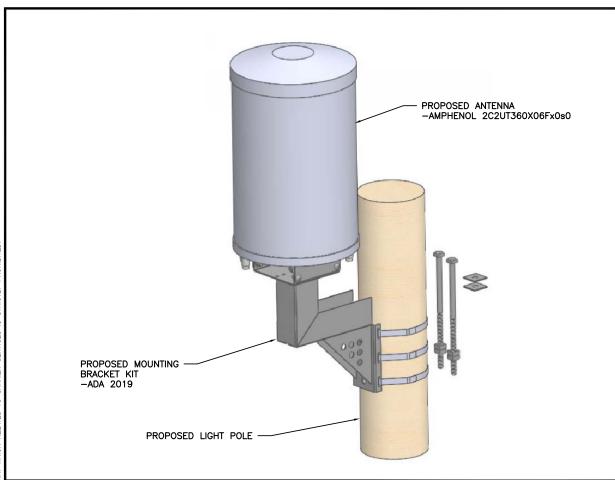

SCALE ANTENNA MOUNTING DETAIL

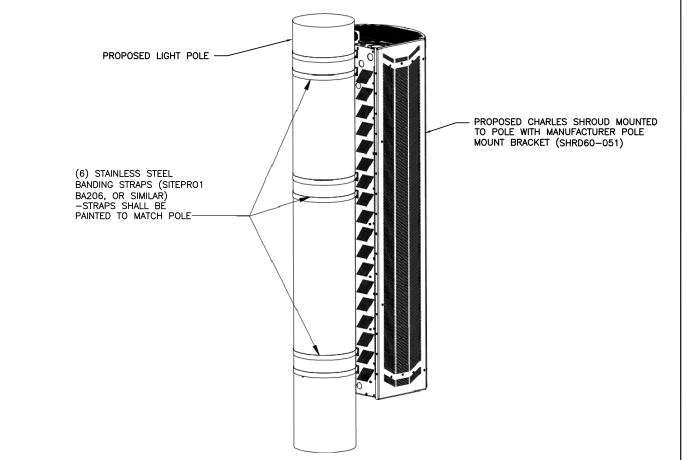

SHROUD MOUNTING DETAIL


EXAMPLE CRAN RF CAUTION SIGN

A CAUTION AT&T operates antennas at this structure Above this point you are entering an area where radio frequency (RF) fields may exceed the FCC General Occupational Exposure limits. Follow safety guidelines for working in an Keep 1 ft. away from the fronts of Contact AT&T at 800-638-2822, opt. 9, 3 and follow their instructions prior to performing any maintenance or repairs

Cell Site USID.

above this point.

EXAMPLE CRAN RF NOTICE SIGN

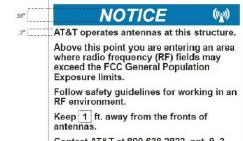

Contact AT&T at 800-638-2822, opt. 9, 3 and follow their instructions prior to performing any maintenance or repairs above this point.

This is AT&T Site USID_

EXAMPLE CRAN POLE POWER DISCONNECT SIGN

DISCONNECT AC & DC

POWER BOTH BEFORE WORKING ON POLE Contact AT&T at 800-638-2822, opt. 9, 3 and follow their instructions prior to performing any maintenance or repairs above this point. Cell Site USID

EXAMPLE STONEHOUSE RD899 RF NOTICE SIGN

NOTICE RF energy emitted by this antenna may exceed the FCC's 16.5 pt. exposure limits for the general population. Stay at least 1 feet away from the antenna. Call AT&T at 800-638-2822, option 9 then 3, for help if you need access within 3 feet. STONEHOUSE RD899

CRAN Pole Power Disconnect, RF Notice, and Caution signs shall be ordered through Stonehouse Signs. Three versions are available for each of the signs shown in Figures 16, 17, and 18: .055 Polyethylene – Reflective, .025 Aluminum – Reflective, and Peel Back Label – Reflective. All versions are 6°x6" with font designed to be visible from 2-3 feet away when approached from below to provide warning about ascending into the high RF exposure areas. The RF Caution sign shown in Figure 19 is designed to be visible from 3 feet away and is available in the reflective peel back label version only. It is designed to fit on most of the CRAN/Small Cell antenna types currently deployed. It may also be placed on antenna shrouds as shown in Figures 11 and 12.

SIGNAGE NOTE:
SIGNAGE SHALL BE INSTALLED PER AT&T DIRECTION





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CIVIL SEAL

LTE 1C&2C PICO CELL BUILD 14805853 CRAN_RCHI_CHUOI_026 184230 784 S LINCOLN AVE CHAMPAIGN, IL 61801

SHEET TITLE

MOUNTING DETAILS

SHEET NUMBER


A8

AT&T SIGNAGE DETAIL

SCALE

N.T.S.

SCALE: NTS

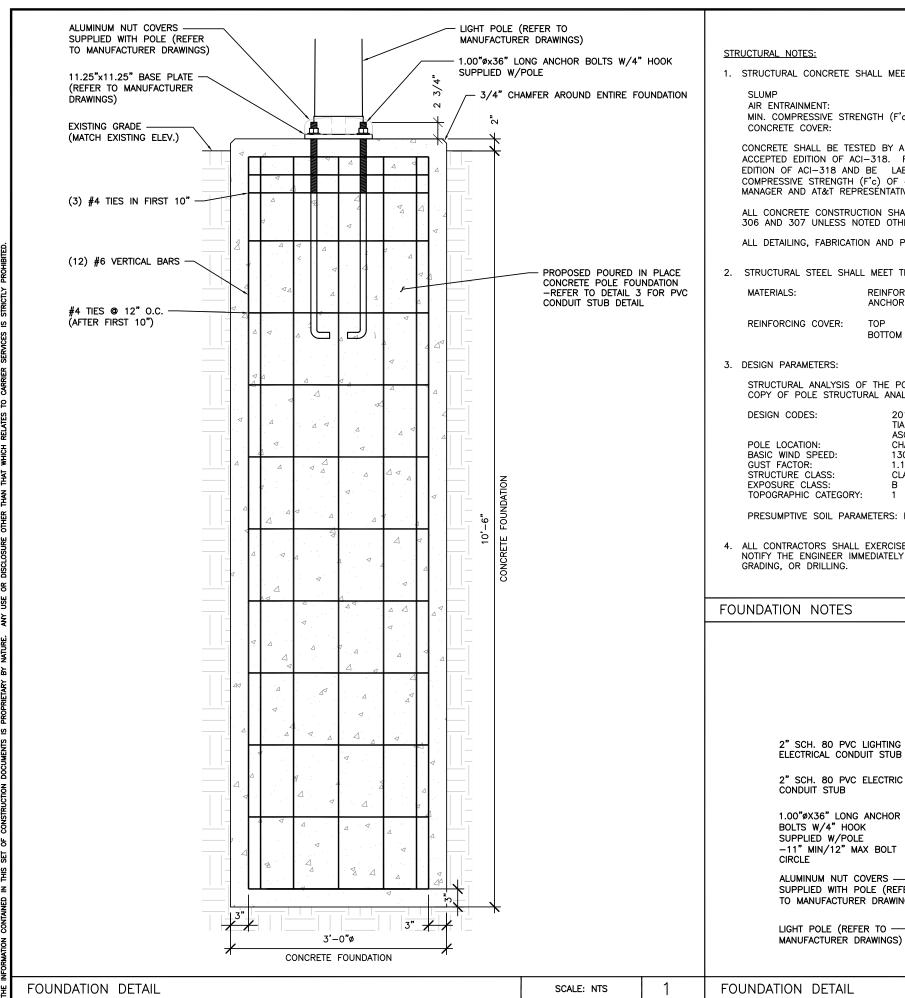

1. STRUCTURAL CONCRETE SHALL MEET THE FOLLOWING SPECIFICATIONS:

 $4" (\pm 1")$ 6% (±1%) MIN. COMPRESSIVE STRENGTH (F'c): 4,500 PSI @ 28 DAYS 3" ALL SIDES

CONCRETE SHALL BE TESTED BY A REPUTABLE INDEPENDENT THIRD PARTY TESTING AGENCY IN ACCORDANCE WITH LATEST WISCONSIN ACCEPTED EDITION OF ACI-318. FIVE (5) CONCRETE CYLINDERS SHALL BE CAST IN ACCORDANCE WITH LATEST WISCONSIN ACCEPTED EDITION OF ACI-318 AND BE LABORATORY CURED. THE AVERAGE OF THREE (3) CONCRETE CYLINDERS SHALL HAVE A MINIMUM COMPRESSIVE STRENGTH (F'c) OF 4,500 PSI AT 28 DAYS. THE TESTING RESULTS SHALL BE PROVIDED TO THE CONSTRUCTION MANAGER AND AT&T REPRESENTATIVE.

ALL CONCRETE CONSTRUCTION SHALL CONFORM TO ACI*96, "STANDARD SPECIFICATION FOR STRUCTURAL CONCRETE" AND ACI 305, 306 AND 307 UNLESS NOTED OTHERWISE.

ALL DETAILING, FABRICATION AND PLACING OF CONCRETE SHALL CONFORM TO ACI 318-11.

2. STRUCTURAL STEEL SHALL MEET THE FOLLOWING SPECIFICATIONS:

REINFORCING ASTM 615, GRADE 60 ANCHOR BOLTS ASTM F1554, GRADE 55

TOP воттом 3"

STRUCTURAL ANALYSIS OF THE POLE AND FOUNDATION WAS COMPLETED BY OTHERS. COORDINATE WITH SAC WIRELESS FOR A COPY OF POLE STRUCTURAL ANALYSIS.

2015 INTERNATIONAL BUILDING BUILDING CODE

TIA-222-G

CHAMPAIGN COUNTY, IL

130 MPH 1.14 CLASS II

PRESUMPTIVE SOIL PARAMETERS: FOUNDATION IS BASED ON AN ALLOWABLE LATERAL BEARING PRESSURE OF AT LEAST 200 PSF/FT.

4. ALL CONTRACTORS SHALL EXERCISE GREAT CARE DURING EXCAVATION. CONTRACTOR SHALL PREDETERMINE UTILITY LOCATIONS AND NOTIFY THE ENGINEER IMMEDIATELY IF DEVIATION FROM PLANS EXIST. CONTRACTOR SHALL CONTACT 811 48 HR. PRIOR TO DIGGING, GRADING, OR DRILLING.

3'-0"ø REINFORCED CONCRETE FOUNDATION 2" SCH. 80 PVC LIGHTING 2" SCH. 80 PVC FIBER ELECTRICAL CONDUIT STUB CONDUIT STUB 2" SCH. 80 PVC ELECTRIC 1.00"øX36" LONG ANCHOR BOLTS W/4" HOOK 1/2" SCH. 80 PVC SUPPLIED W/POLE GROUNDING CONDUIT STUB -11" MIN/12" MAX BOLT ALUMINUM NUT COVERS -SUPPLIED WITH POLE (REFER 11.25"X11.25" BASE PLATE TO MANUFACTURER DRAWINGS) (REFER TO MANUFACTURER DRAWINGS) LIGHT POLE (REFER TO





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STRUCTURAL SEAL

SCALE

N.T.S.

2

3

SCALE: NTS


LTE 1C&2C PICO CELL BUILD 14805853 CRAN_RCHI_CHUOI_026 184230 784 S LINCOLN AVE CHAMPAIGN, IL 61801


SHEET TITLE

POLE FOUNDATION DETAILS

SHEET NUMBER

S1

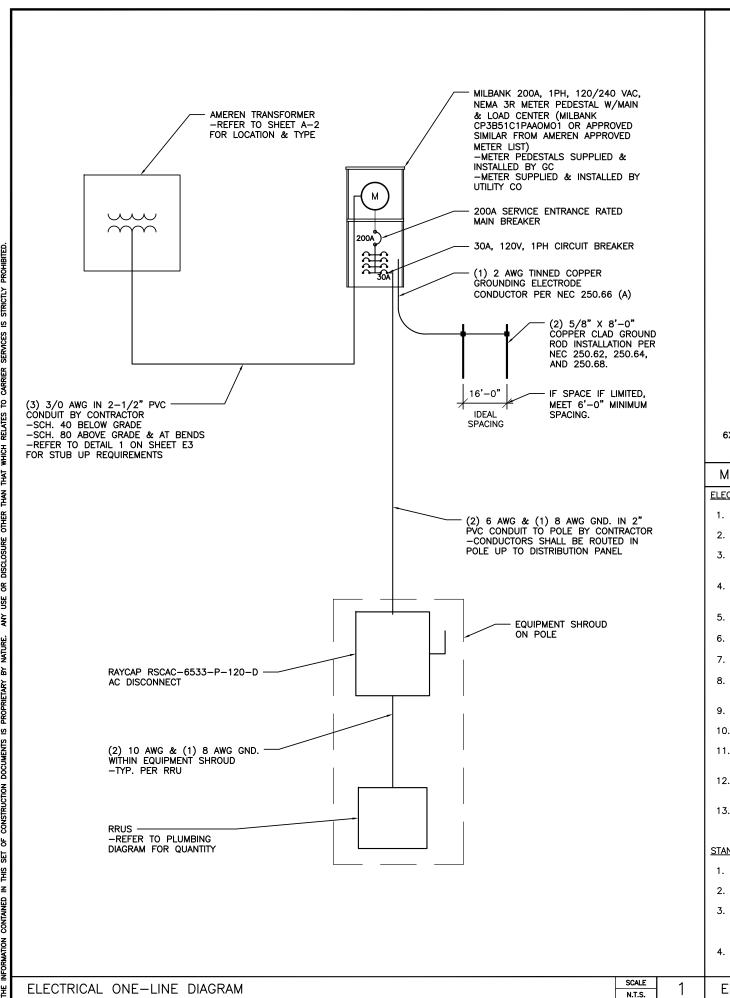

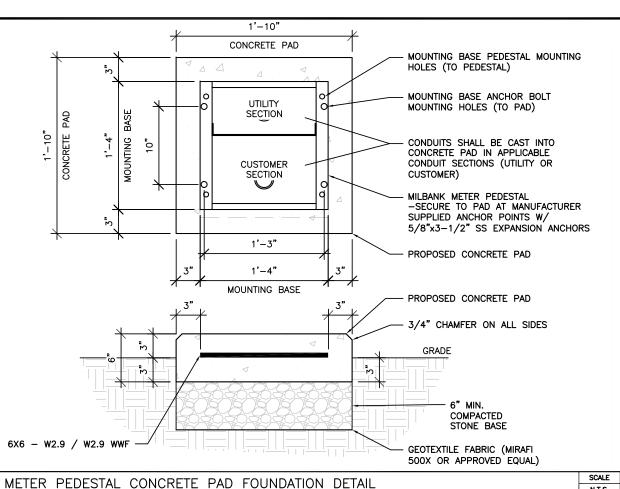

ELECTRICAL NOTES:

- 1. ALL ELECTRICAL WORK SHALL BE IN ACCORDANCE WITH THE PROJECT SPECIFICATIONS AND ALL APPLICABLE CODES.
- 2. CONDUIT ROUTINGS ARE SCHEMATIC. SUBCONTRACTOR SHALL INSTALL CONDUITS SUCH THAT ACCESS TO EQUIPMENT IS NOT BLOCKED.
- 3. SUBCONTRACTOR IS RESPONSIBLE FOR PROPERLY SEQUENCING THE INSTALLATION OF GROUNDING AND UNDERGROUND CONDUIT AS TO PREVENT THE LOSS OF CONTINUITY IN THE GROUNDING SYSTEM OR DAMAGE TO THE CONDUIT.
- 4. COMPRESSION GROUND CONNECTIONS MAY BE REPLACED BY EXOTHERMIC (CADWELD) CONNECTIONS WHEN APPROVED BY CINCINNATI BELL CONSTRUCTION MANAGER.
- 5. SERVICE TO METER PEDESTAL SHALL BE 120/240VAC, 200 AMP, SINGLE PHASE.
- 6. ALL GROUND CONNECTIONS BELOW GRADE SHALL BE EXOTHERMIC (CADWELD).
- 7. ALL GROUND CONNECTIONS ABOVE GRADE SHALL BE FORMED USING TWO (2) HIGH PRESS CRIMPS.
- 8. ALL EXOTHERMIC CONNECTIONS TO THE GROUND RODS SHALL START AT THE TOP AND HAVE A VERTICAL SEPARATION OF 6" FOR EVERY ADDITIONAL CONNECTION.
- 9. ALL EXTERIOR GROUND CONNECTIONS SHALL BE COATED WITH A CORROSION RESISTANT MATERIAL.
- 10. ALL EXTERIOR GROUND CONNECTORS SHALL BE 2 AWG SOLID BARE, TINNED, COPPER UNLESS INDICATED OTHERWISE.
- 11. CONNECTIONS TO THE GROUND BUS SHALL NOT BE DOUBLED UP OR STACKED. BACK TO BACK CONNECTIONS ON OPPOSITE SIDES OF THE GROUND BUS ARE PERMITTED.
- 12. USE OF 90' BENDS IN THE PROTECTION GROUNDING CONDUCTORS SHALL BE AVOIDED WHEN 45' BENDS CAN BE ADEQUATELY
- 13. MAXIMUM RESISTANCE OF THE COMPLETED GROUND SYSTEM SHALL NOT EXCEED 5 OHMS. TESTING SHALL BE PERFORMED IN ACCORDANCE WITH PROJECT SPECIFICATIONS FOR FACILITY GROUNDING, USING FALL OF POTENTIAL METHOD.

STANDARD CONDUIT NOTES:

- 1. UNDERGROUND CONDUIT SHALL BE SCHEDULE 40 PVC. ABOVE GROUND CONDUIT, ELBOWS, AND RISERS SHALL BE SCHEDULE 80 PVC.
- 2. UNDERGROUND SERVICE CONDUIT SHALL MEET REQUIRED BURIAL DEPTH PER AMEREN ELECTRIC SERVICE MANUAL.
- 3. G.C. TO STUB UP SERVICE CONDUIT AT UTILITY POLE WITH 90' SWEEPING ELBOW. GC. SHALL COIL SUFFICIENT CONDUCTOR TO REACH SERVICE CONNECTION ON POLE. G.C. SHALL SUPPLY ENOUGH CONDUIT AND RISER HARDWARE FOR AMEREN TO EXTEND SERVICE RISER UP POLE TO SERVICE CONNECTION POINT. REFER TO AMEREN ELECTRIC SERVICE MANUAL FOR REQUIREMENTS.
- 4. ALL CONDUIT WILL BE EQUIPPED WITH 3/8" PULL ROPE AND HAVE A TRACER WIRE. TRACER WIRE NEEDS TO BE LAID ABOVE BURIED CONDUIT.







520 South Main Street, Suite 2531 Akron, OH 44311 330.572.2100 Fax: 330.572.2102

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ı	REV.	DATE	DESCRIPTION	INITIALS
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LABELED AS CONSTRUCTION SET

ELECTRICAL SEAL

LTE 1C&2C PICO CELL BUILD 14805853 CRAN_RCHI_CHUOI_026 184230 784 S LINCOLN AVE CHAMPAIGN, IL 61801

SHEET TITLE

ELECTRICAL ONE-LINE DIAGRAM


SHEET NUMBER

E1

ELECTRICAL NOTES

SCALE N.T.S.

N.T.S.

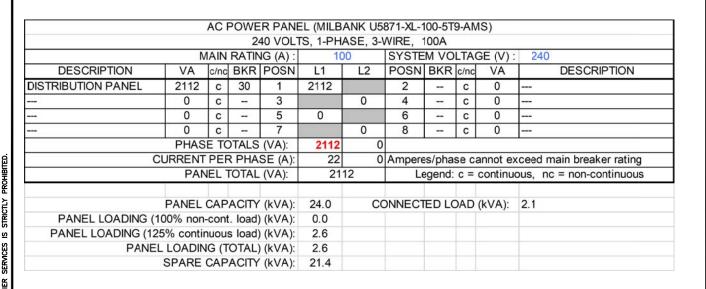

MANUFACTURER: MODEL: MILBANK CP3B51C1PAAOMO1


ELECTRICAL SPECIFICATIONS:
AMPERAGE RATING:
OPERATING VOLTAGE:
ELECTRICAL PHASE:
MAIN BREAKER SIZE:
GTY OF BRANCH CIRCUITS:
LINE SIDE WIRE RANGE: 200 A 240 V 1 PH 200 A 20 6 AWG — 350 kcmil

ENVIRONMENT SPECIFICATIONS: UL LISTED: NEMA RATING:

ADDITIONAL SPECIFICATIONS:
ON AMEREN ENERGY APPROVED LIST (SECTION 1100 OF ELECTRIC SERVICE MANUAL, DATED JANUARY 18, 2018)



"A" Style 16" Metered Commercial Pedestal

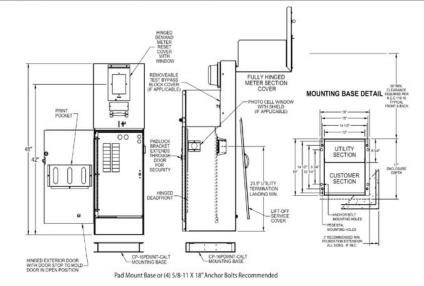

SPECIAL NOTE:
METER PEDESTAL SHALL BE PAINTED TO MATCH AT&T EQUIPMENT IN
RIGHT OF WAY. CONTRACTOR SHALL COORDINATE W/AT&T FOR COLOR
AND PROVIDE DOCUMENTATION OF SUCH TO CITY OF URBANA FOR

ELECTRICAL MAIN & LOAD CENTER PANEL SCHEDULE

SCALE N.T.S.

AC METER SOCKET W/MAIN & LOAD CENTER DETAIL

SCALE N.T.S.

MECHANICAL SPECIFICATIONS: HEIGHT: WIDTH: DEPTH: WEIGHT:

MANUFACTURER: MODEL:

ELECTRICAL SPECIFICATIONS: AMPERAGE: OPERATING VOLTAGE:
QTY OF PROTECTED CIRCUITS:
CONNECTION TERMINALS:

ENVIRONMENT SPECIFICATIONS: NORMAL OPERATING TEMP.: ENVIRONMENT:

RAYCAP RSCAC-6533-P-120-D

10.45 IN (265.43 mm) 10.28 IN (261.11 mm) 7.46 IN (189.48 mm) 1.25 LBS (1.02 kg)

COMPRESSION LUGS (6 AWG-14 AWG) TERMINAL BLOCK (10 AWG-26 AWG)

-40°C TO +80°C OUTDOOR CLASS NEMA 4X POLYCARBONATE UL 94V-O RATED









520 South Main Street, Suite 2531 Akron, OH 44311 330.572.2100 Fax: 330.572.2102

DEMICIONE										
	R	EVISIONS								
REV.	DATE	DESCRIPTION	INITIALS							
Α	10/31/18	ISSUED FOR REVIEW	SEK							
В	03/12/19	REVISED PER COMM.	MRL							

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ELECTRICAL SEAL

LTE 1C&2C PICO CELL BUILD 14805853 CRAN_RCHI_CHUOI_026 184230 784 S LINCOLN AVE CHAMPAIGN, IL 61801

SHEET TITLE

IPANEL SCHEDULE & ELECTRICAL **DETAILS**

SHEET NUMBER


E2

AC POWER PANEL (RAYCAP RSCAC-6533-P-120-D)											
	120 VOLTS, 1-PHASE, 2-WIRE, 30A										
	N			IG (A):		0	SYSTE	M VO	LTA	GE (V):	120
DESCRIPTION	VA	c/nc	BKR	POSN	L1	L2	POSN	BKR	c/nc	VA	DESCRIPTION
RRUS-2203	704	С	7	1	1408		2	7	С	704	RRUS-2205
RRUS-2203	704	С	7	3		704	4	7	С	0	
	1408	704					•				
CURRENT PER PHASE (A):					15	7	Amperes/phase cannot exceed main breaker rating				ceed main breaker rating
	PAN	EL.	TOTAL	(VA):	21	12	Le	egend:	c =	continu	ous, nc = non-continuous
	PANEL	CAP	ACITY	(kVA):	3.6	CC	DNNECT	ED LC	DAD	(kVA):	2.1
PANEL LOADING (1	00% non-	-cont	t. load)	(kVA):	0.0						
PANEL LOADING (125% continuous load) (kVA):											
PANEL	2.6										
	SPARE	CAP	ACITY	(kVA):	1.0						

SCALE ELECTRICAL PANEL SCHEDULE AC DISTRIBUTION PANEL DETAIL N.T.S.

SCALE

N.T.S.

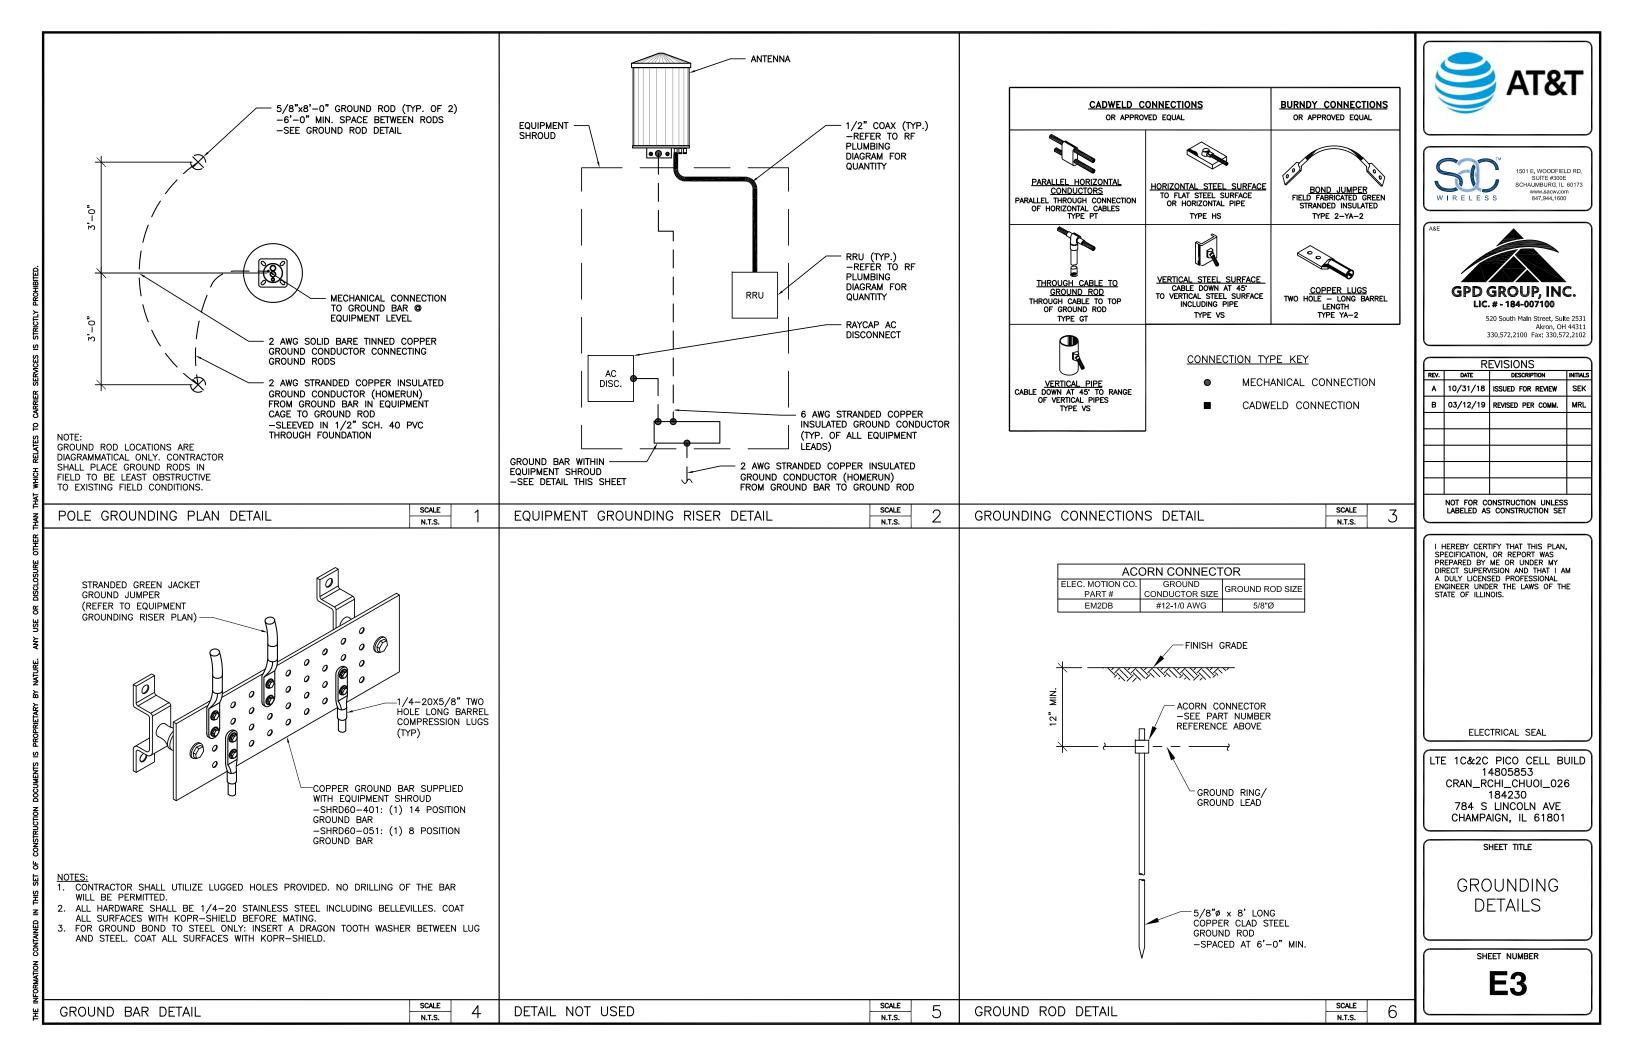

	Configuration Name			850 MHz 2T2R LTE	William Co.	The second second					3.5 GHz LAA LTE	and the same		A DESCRIPTION OF THE PARTY OF T
١	Pico #02	NA	NA	NA	NA	NA	Х	NA	NA	Х	NA	1	2	14 Ports Antenna

Amphenol Pseudo-Omni – 14 ports Antenna 2C2U3MT360X06Fxys0



Important Note:


For detailed radio to antenna wiring refer to the latest 4T4R Antenna/Radio Port Connection Field Notice (RF-HW-2016-234) and the 4T Wiring Playbook

Two Radios

- B2 (PCS) CEQ.18155
- B66A (AWS) CEQ.18167
 One Radio/One Dummy Radio
- B46 (LAA) CEQ.18245



- HXWXD 17.12" X 7.87" X 4.13"
- WEIGHT 21 LBS.
- POWER CONSUMPTION WATTS MAX
- MINIMUM AC FUSE RATING 8 AMP
- MAX HEAT DISSIPATION 20 WATTS

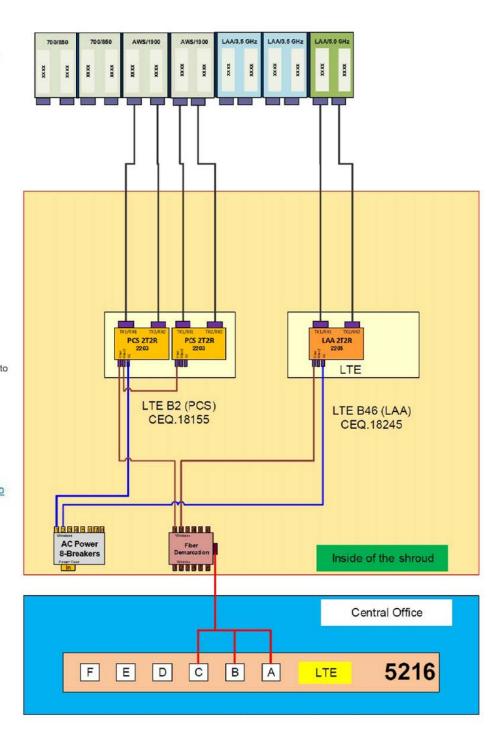





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	R	EVISIONS	1
REV.	DATE	DESCRIPTION	INITIALS
Α	10/31/18	ISSUED FOR REVIEW	SEK
В	03/12/19	REVISED PER COMM.	MRL

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REFERENCE ONLY

LTE 1C&2C PICO CELL BUILD 14805853 CRAN_RCHI_CHUOI_026 184230 784 S LINCOLN AVE CHAMPAIGN, IL 61801

SHEET TITLE

RF PLUMBING DIAGRAM

SHEET NUMBER

RF1

RF PLUMBING DIAGRAM

SCALE N.T.S.

Round Tapered Aluminum Pole with Arms Double Davit — 4-Bolt Base J Arm Length Twin Arm @ 180° 3° 4-1/2" O.D. **K** Bend Radius 2" NPS Slipfitter (Options Available -See Accessory .188" Arm Wall Thickness Specifications) Aluminum Alloy 6063-T6 1/2"-13NC S. S. Lockbolt Flush Joint **D** Top Diameter **Mounting Height B** Wall Thickness **Tapered Aluminum Tube** Alloy 6063-T6 K ARM LENGTH RADIUS 4' 3 6' 3' 8' 5' 10 5' Handhole C Butt Diameter 4-Bolt Base With Bolt Covers Satin Aluminum or Powder Coated Finish per Customer Specification.

C Butt Dia.	D Top Dia.	F Bolt Cir. Dia.	G Base Sq.	H Bolt Proj.	BOLT SIZE
6	4.5	9 - 10	9.75	2.75	1 x 36 x 4
7	4.5	10 - 11	10.5	2.75	1 x 36 x 4
8	4.5	11 - 12	11.25	2.75	1 x 36 x 4
10	6	14 - 15	14	3.25	1 x 48 x 4

Dimensions in Inches

Pole

Shaft and arms will be constructed of seamless extruded tube of 6063 Aluminum Alloy per the requirements of ASTM B221. The shaft assembly shall be full-length heat treated after base weld to produce a T6 temper.

Base Style

4-Bolt Cast Aluminum Base Flange of Alloy 356-T6 with Aluminum Bolt Covers (Alloy 356-F) and Stainless Steel Hex Head Attaching Screws.



Handhole


6" Butt Diameter - Reinforced, 3" x 5" curved Cast Aluminum Frame (Alloy 356-T6) with Aluminum Door and two (2) SS Hex Head Screws. A Grounding Provision incorporating a 3/8" diameter hole is provided opposite the Handhole.

7"+ Butt Diameters -Reinforced, 4" x 6" curved Cast Aluminum Frame (Alloy 356-T6) with Aluminum Door and two (2) SS Hex Head Screws. Reinforced Frame will contain a tapped 3/8"-16NC Grounding Provision.



Anchorage

Anchorage Kit will include four (4) L-shaped Steel Anchor Bolts conforming to AASHTO M314-90 Grade 55. Ten inches (10") of threaded end will be galvanized per ASTM Å153. Kits will contain four (4) Hex Nuts, four (4) Lock Washers, and four (4) Flat Washers (all components Galvanized Steel). A bolt circle template will be provided.

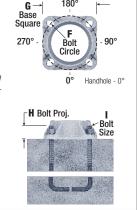

Vibration Damper

When determined necessary by Hapco, a Vibration Damper will be factory-installed inside the pole shaft. Customer specification of the damper is available.



A Mtg. Hgt.	B Wall Thickness	C Butt Diameter	J Arm Length	Lum. Weight	90	Maximui 100	w EPA 110		RM 130	OLD Cat. Number	Catalog Number
20	0.156''	6	4'	35	5.8	4.2	3.7	2.7	2.0	42-031	RTA20C6B4D24-**
20	0.156''	6	6'	35	5.4	3.7	3.2	2.2	1.5	42-032	RTA20C6B4D26-**
20	0.156''	6	8'	35	4.7	3.1	2.6	1.6	0.9	42-033	RTA20C6B4D28-**
20	0.188''	6	4'	35	7.5	5.6	5.0	3.8	2.9	42-001	RTA20D6B4D24-**
20	0.188''	6	6'	35	7.0	5.0	4.5	3.3	2.4	42-002	RTA20D6B4D26-**
20	0.188'' 0.156''	6 7	8' 4'	35 35	6.4 9.2	4.4 7.0	3.9 6.3	2.7 4.9	1.8 3.8	42-003 42-025	RTA20D6B4D28-** RTA20C7B4D24-**
20	0.156''	7	6'	35	8.8	6.4	5.8	4.4	3.3	42-025	RTA20C7B4D24*
20	0.156''	7	8'	35	8.2	5.8	5.2	3.8	2.7	42-027	RTA20C7B4D28-**
20	0.188''	7	4'	35	11.6	8.8	8.1	6.4	5.1	42-007	RTA20D7B4D24-**
20	0.188''	7	6'	35	11.2	8.4	7.6	5.9	4.6	42-008	RTA20D7B4D26-**
20	0.188''	7	8'	35	10.4	7.8	7.0	5.3	4.0	42-009	RTA20D7B4D28-**
25	0.156''	6	4'	35	3.1	1.8	1.5	0.8	-		RTA25C6B4D24-**
25 25	0.156'' 0.188''	6	6' 4'	35 35	2.5	1.3	1.0	- 1.7	1.0	42-073	RTA25C6B4D26-** RTA25D6B4D24-**
25	0.188''	6	6'	35	3.8	2.4	2.0	1.1	0.5	42-073	RTA25D6B4D26-**
25	0.188''	6	8'	35	3.2	1.7	1.3	0.5	-	42-075	RTA25D6B4D28-**
25	0.188''	6	10'	35	2.6	1.1	0.7	-	-	42-076	RTA25D6B4D2A-**
25	0.156''	7	4'	35	5.6	4.0	3.5	2.5	1.7	42-103	RTA25C7B4D24-**
25	0.156''	7	6'	35	5.2	3.4	3.0	2.0	1.2	42-104	RTA25C7B4D26-**
25	0.156''	7	8'	35	4.5	2.8	2.3	1.3	0.6	42-105	RTA25C7B4D28-**
25	0.156''	7	10'	35	3.9	2.2	1.7	0.7	- 2.7	42-106	RTA25C7B4D2A-**
25 25	0.188'' 0.188''	7 7	4' 6'	35 35	7.4	5.4 4.9	4.8	3.6	2.7	42-079 42-080	RTA25D7B4D24-** RTA25D7B4D26-**
25	0.188''	7	8'	35	6.3	4.2	3.7	2.5	1.5	42-081	RTA25D7B4D20-
25	0.156''	8	6'	35	7.1	5.1	4.7	3.5	2.5	.2 001	RTA25C8B4D26-**
25	0.156''	8	8'	35	6.5	4.5	4.1	2.9	1.9		RTA25C8B4D28-**
25	0.156''	8	10'	35	5.9	3.9	3.5	2.3	1.5		RTA25C8B4D2A-**
25	0.188''	8	4'	35	11.0	8.4	7.6	6.0	4.7	42-085	RTA25D8B4D24-**
25 25	0.188'' 0.188''	8	6' 8'	35 35	10.6	7.9 7.2	7.1 6.5	5.5 4.8	4.2 3.5	42-086 42-087	RTA25D8B4D26-** RTA25D8B4D28-**
25	0.188''	8	10'	35	9.4	6.6	5.9	4.0	2.9	42-087	RTA25D8B4D2A-**
30	0.188''	6	4'	35	2.1	1.0	0.7	-	-	12 000	RTA30D6B4D24-**
30	0.156''	7	4'	35	3.2	1.9	1.5	0.8	-	42-145	RTA30C7B4D24-**
30	0.156''	7	6'	35	2.6	1.3	1.0	-	-	42-146	RTA30C7B4D26-**
30	0.156''	7	8'	35	2.0	0.7	-	-	-	42-147	RTA30C7B4D28-**
30	0.156''	8	4' 6'	35	5.3	3.7	3.3	2.3	1.5	42-175	RTA30C8B4D24-**
30	0.156'' 0.156''	8	8'	35 35	4.9	3.1	2.7	1.7	1.0	42-176 42-177	RTA30C8B4D26-** RTA30C8B4D28-**
30	0.156''	8	10'	35	3.5	1.9	1.5	0.5	-	42-178	RTA30C8B4D2A-**
30	0.188''	8	4'	35	7.5	5.4	4.8	3.6	2.6	42-157	RTA30D8B4D24-**
30	0.188''	8	6'	35	7.0	4.8	4.3	3.0	2.1	42-158	RTA30D8B4D26-**
30	0.188''	8	8'	35	6.2	4.2	3.6	2.4	1.4	42-159	RTA30D8B4D28-**
30	0.188''	8	10'	35	5.6	3.6	3.0	1.7	0.8	42-160	RTA30D8B4D2A-**
30	0.219''	8	4' 6'	35 35	9.2	6.8	6.2 5.6	4.7	3.6	42-163 42-164	RTA30E8B4D24-** RTA30E8B4D26-**
30	0.219''	8	8'	35	8.0	5.6	5.0	3.5	2.4	42-165	RTA30E8B4D28-**
30	0.219''	8	10'	35	7.4	5.0	4.4	2.8	1.8	42-166	RTA30E8B4D2A-**
30	0.250''	8	4'	35	11.0	8.2	7.5	5.8	4.6	42-169	RTA30F8B4D24-**
30	0.250''	8	6'	35	10.6	7.8	7.0	5.3	4.0	42-170	RTA30F8B4D26-**
30	0.250''	8	8'	35	9.8	7.0	6.3	4.6	3.4	42-171	RTA30F8B4D28-**
30	0.250''	8	10' 4'	35 35	9.2	6.4 1.9	5.6 1.5	<u>4.0</u> 0.7	2.7	42-172 42-223	RTA30F8B4D2A-** RTA35C8B4D24-**
35	0.156''	8	6'	35	2.7	1.3	1.0	-	-	42-223	RTA35C8B4D26-**
35	0.156''	8	8'	35	2.0	0.6	-	-	-	42-225	RTA35C8B4D28-**
35	0.188''	8	4'	35	4.8	3.2	2.7	1.8	1.1	42-229	RTA35D8B4D24-**
35	0.188''	8	6'	35	4.3	2.6	2.2	1.2	0.5	42-230	RTA35D8B4D26-**
35	0.188''	8	8'	35	3.6	1.9	1.5	0.5	-	42-231	RTA35D8B4D28-**
35 35	0.188'' 0.219''	8	10' 4'	35 35	3.0	1.3	0.8	2.7	- 1.9	42-232 42-235	RTA35D8B4D2A-** RTA35E8B4D24-**
35	0.219	8	6'	35 35	5.8	3.8	3.8	2.7	1.9	42-235	RTA35E8B4D24-**
35	0.250''	8	4'	35	7.8	5.6	5.0	3.6	2.6	42-241	RTA35F8B4D24-**
35	0.250''	8	6'	35	7.2	5.0	4.4	3.1	2.1	42-242	RTA35F8B4D26-**
35	0.250''	8	8'	35	6.6	4.3	3.7	2.4	1.4	42-243	RTA35F8B4D28-**
35	0.250''	8	10'	35	5.8	3.6	3.0	1.8	0.8	42-244	RTA35F8B4D2A-**
35	0.188''	10	8'	35	9.4	6.8	6.0	4.4	3.1	42-249	RTA35D1C4D28-**
35 40	0.188''	10 8	10' 4'	35 35	8.8	6.2 1.4	5.4 1.1	3.8	2.4	42-250 42-325	RTA35D1C4D2A-** RTA40D8B4D24-**
40	0.188''	8	6'	35	2.2	0.8	0.5	-	-	42-323	RTA40D8B4D24-
40	0.188''	8	8'	35	1.5	-	-	-	-	42-327	RTA40D8B4D28-**
40	0.250''	8	4'	35	5.2	3.4	3.0	1.9	1.1	42-337	RTA40F8B4D24-**
40	0.250''	8	6'	35	4.7	2.8	2.4	1.3	0.6	42-338	RTA40F8B4D26-**
40	0.250''	8	8'	35	4.0	2.2	1.7	0.6	-	42-339	RTA40F8B4D28-**
40	0.250'' 0.188''	8 10	10' 6'	35 35	3.3	1.5 5.0	1.0	3.0	2.0	42-340 42-375	RTA40F8B4D2A-**
40	0.188''	10	8'	35	7.0	4.3	3.8	2.4	1.3	42-375	RTA40D1C4D26-** RTA40D1C4D28-**
40	0.188''	10	10'	35	5.8	3.6	3.1	1.8	0.7	42-364	RTA40D1C4D20-
40	0.250''	10	10'	35	9.8	7.0	6.2	4.4	2.9	42-376	RTA40F1C4D2A-**

Catalog Number System

The catalog number for Hapco poles utilizes the following identification system.



Catalog Number Example -

RTA 30 D 8 B 4 D 2 6 - 01

Round Tapered Aluminum, 30' Mounting Height, .188" Wall Thickness, 8" Butt Diameter, 4.5" Top Diameter, 4-Bolt Base, Davit Arm, Double, 6' Arm Length, Satin Aluminum Finish.

Wall Thickness

C = .156"

D = .188"

E = .219"

F = .250"

Butt Diameter

6 = 6"

7 = 7"

8 = 8"

1 = 10"

Top Diameter

B = 4.5"

C = 6"

Base Style

4 = 4-Bolt Base

Arm Style

D = Davit

Arm Quantity

2 = Double

Arm Length

4 = 4'

6 = 6'

8 = 8'

A = 10'

Finish

01 = Satin Aluminum

BA = Black Powder Coat

BH = White Powder Coat

BM = Dark Bronze Powder Coat

BV = Dark Green Powder Coat

GC = Gray Powder Coat

** = Specify Finish

EPA Notes:

Effective Projected Area (EPA) in square feet. EPA's calculated using wind velocity (mph) indicated in accordance with 2009 AASHTO LTS-5 using a 25 year design life. Maximum EPA is based on the luminaire weight shown. Increased luminaire weight may reduce the maximum EPA. If weight is exceeded, or if other design life or code is required, please consult the factory.

